11 12 13 14



# JACKSON-MEDGAR WILEY EVERS INTERNATIONAL AIRPORT



SHEET INDEX  DRAWINGS							
СР	1	COVER PAGE AND SHEET INDEX					
AP-2.0	1	NEW AIRCRAFT PARKING LAYOUT - GATE 2					
PBB-0.1	1	SYMBOLS & ABBREVIATIONS					
PBB-0.2	1	PASSENGER BOARDING BRIDGE GENERAL NOTES					
PBB-1.0	1	EXISTING PASSENGER BOARDING BRIDGE LAYOUT — GATE 2					
PBB-2.0	1	NEW PASSENGER BOARDING BRIDGE LAYOUT — GATE 2					
PBB-3.1	1	PASSENGER BOARDING BRIDGE DETAILS — PART ONE					
PBB-3.2	1	PASSENGER BOARDING BRIDGE DETAILS — PART TWO					
PBB-4.1	1	NEW PCA DETAILS — PART ONE					
PBB-4.2	1	NEW PCA DETAILS — PART TWO					
PBB-4.3	1	NEW PCA DETAILS — PART THREE					
PBB-5.1	1	PUSHBUTTON DETAILS AND AIRCRAFT CABLE DETAILS					
PBB-5.2	1	CABLE HOIST DETAILS – GATE 2					
PBB-5.3	1	400HZ EQUIPMENT DETAILS					
S0.1	1	STRUCTURAL GENERAL NOTES					
S1.1	1	FOUNDATION PLANS					
S5.1	1	FOUNDATION DETAILS					
		SPECIFICATIONS					
118502	1	POU DX PCA UNITS					
118504	1	PASSENGER BOARDING BRIDGE					
118560	1	AIRCRAFT GROUND POWER CABLE					
118561	1	SOLID STATE FREQUENCY CONVERTER					

JAN PASSENGER BOARDING BRIDGE REPLACEMENT PROJECT Allen & Hoshall, P.L.L.C.
Michel Lebel, Architect
1675 Lakeland Drive, Suite 207
Jackson, Mississippi 39216

COPYRIGHT
Allen & Hoshall
This document is proprietary to Allen &
Hoshall and shall not be reproduced or used by others without prior written consent.

JMAA JET BRIDGE 2

JACKSON MUNICIPAL AIRPORT AUTHORITY

100 INTERNATIONAL DRIVE STE 300

JACKSON MS 39298

COVER PAGE AND SHEET INDEX


JOB NO: 62960

DATE: 08/18/21


DRAWN: BWW

CHECKED: CRB

CAD FILE:

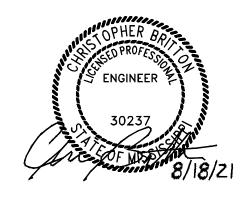

CP

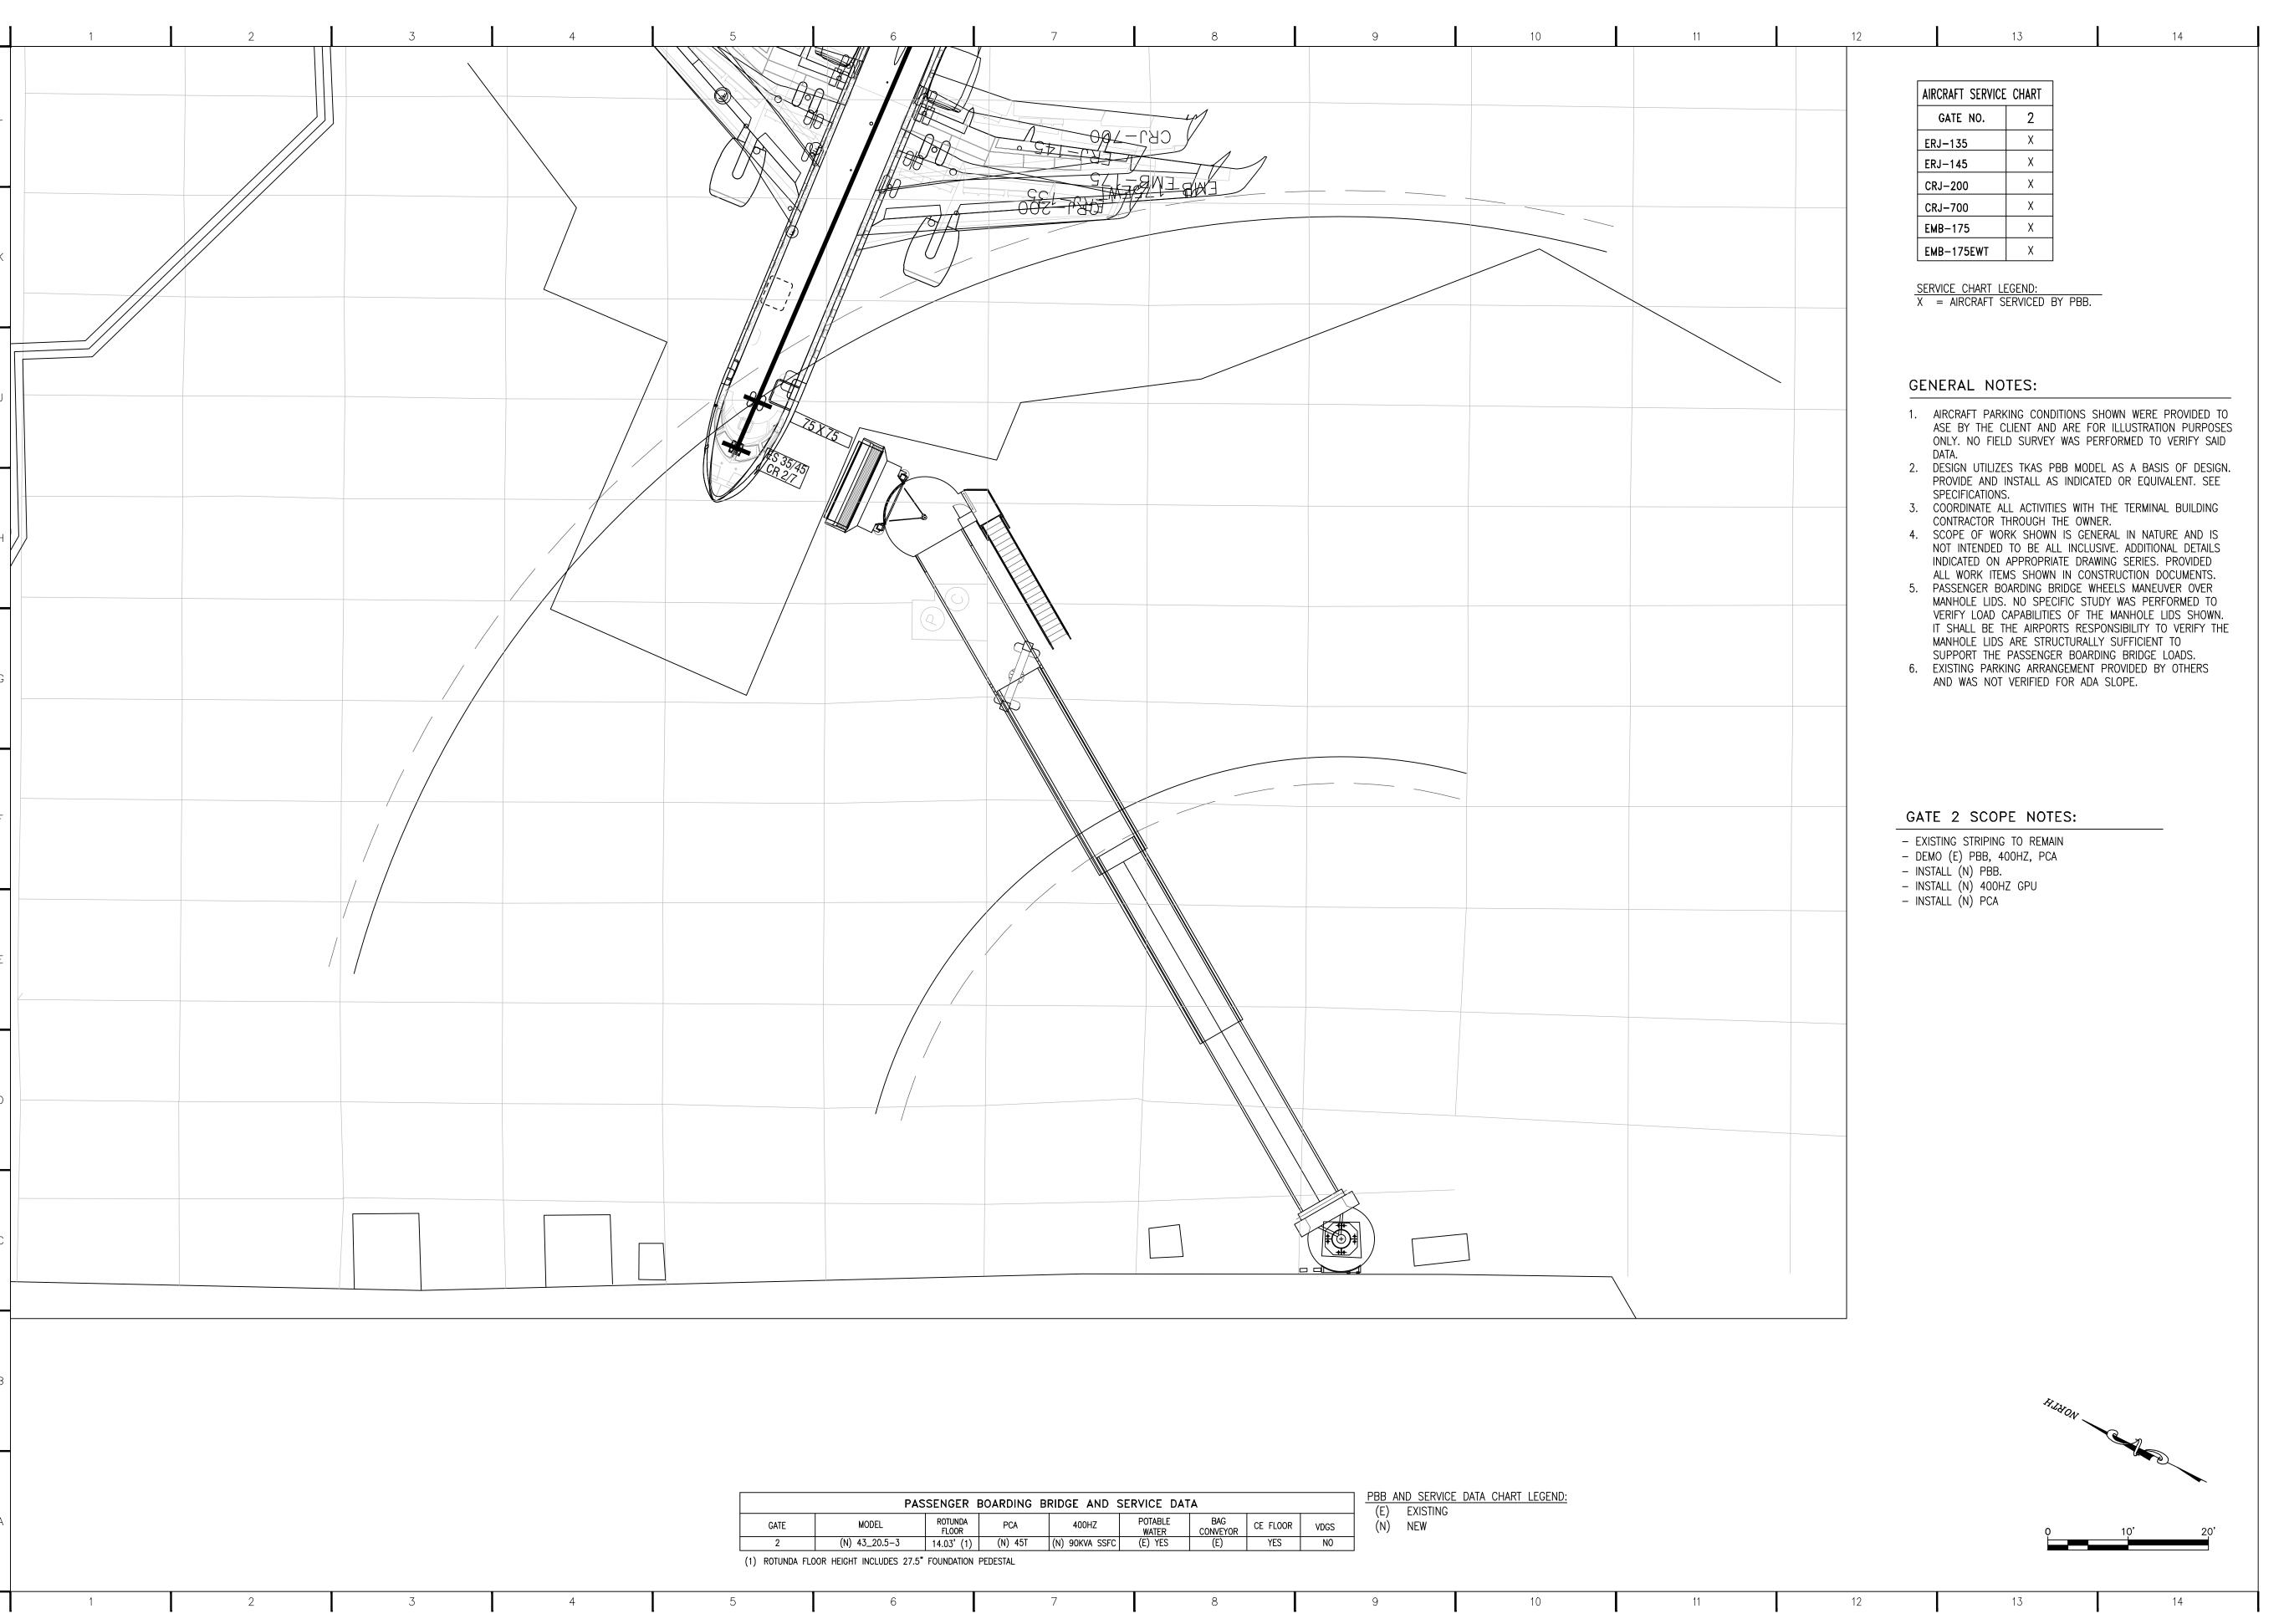



> COPYRIGHT Allen & Hoshall

This document is proprietary to Allen & Hoshall and shall not be reproduced or used by others without prior written consent.

JMAA JET BRIDGE 2

JACKSON MUNICIPAL AIRPORT AUTHORITY 100 INTERNATIONAL DRIVE STE 300 Jackson, ms 39298

1 REVISION XXX XX/XX/X
NO REVISION DATE

NEW AIRCRAFT PARKING LAYOUT — GATE 2

JOB NO: 62960

DATE: 08/18/21

DRAWN: BWW

CHECKED: CRB

CAD FILE:



AP-2.0

		5 6 7	0	9 10 11		12 13 14		
J	JUNCTION BOX		Α	AMP OR AMPERE	KVA	KILOVOLT AMPERE		
U	CONCTION BOX		ADGS	AIRCRAFT DOCKING GUIDANCE SYSTEM - AUTOMATIC	KW	KILOWATT		
	CEILING MOUNTED JUNCTION BOX		ADGU	AIRCRAFT DOCKING UNIT - MANUAL	MLO	MAIN LUG ONLY		
(1)	CLILING MOUNTED JUNCTION BOX		AHU	AIR HANDLER UNIT	MNPT	MALE NATIONAL PIPE THREAD		
	PIN AND SLEEVE TYPE 3R CONNECTOR		AIC	AMPERE INTERRUPTING CAPACITY	(N)	NEW		
	FIN AND SELEVE TIPE SIX CONNECTOR		AFF	ABOVE FINISHED FLOOR	N1	NEMA 1 OR INDOOR ENCLOSURE		
	PUSH-BUTTON STATION		AISC	AMERICAN INSTITUTE OF STEEL CONSTRUCTION	N3R	NEMA 3R OR OUTDOOR ENCLOSURE		
•	FUSIT-BUTTON STATION		AL	ALUMINUM	NEC	NATIONAL ELECTRICAL CODE		
	DISCONNECT SWITCH - SIZE/POLES/FUSE/ENCLOSURE MOUNT 48" AFF		ALRC	ALUMINUM RIGID CONDUIT	NF	NON-FUSIBLE		
	DISCONNECT SWITCH SIZE/TOLES/TOSE/ ENGLOSONE MOONT TO ALT		ASE	AERO SYSTEMS ENGINEERING, INC.	NIC	NOT IN CONTRACT		
	EQUIPMENT CONTROLLER		ASY	ASYMMETRICAL	NTS	NOT TO SCALE		
_	EQUII MIENT CONTROLLER		AWG	AMERICAN WIRE GAUGE	OCP	OVER CURRENT PROTECTION		
	COMBINATION MOTOR CONTROLLER DISCONNECT SWITCH		AWS	AMERICAN WELDING SOCIETY	Р	POLE		
	SIZE/POLES/FUSE/ENCLOSURE MOUNT 48" AFF		BDP	BRIDGE DISTRIBUTION PANEL	PBB	PASSENGER BOARDING BRIDGE, PASSENGER LOADING BRIDGE, OR LOADING BRIDGE		
	FUSED DISCONNECT SWITCH		С	CONDUIT	PCA	PRECONDITIONED AIR		
<u> </u>	FUSED DISCONNECT SWITCH		CKT	CIRCUIT	POU	POINT OF USE		
<u> </u>	o FUCE		CLF	CURRENT LIMITING FUSE	PVC	POLYVINYL CHLORIDE CONDUIT		
OR •	y ruse		СТ	CURRENT TRANSFORMER	PW	POTABLE WATER		
7	FLEVIDLE DIAFRINA (LIQUID TIGHT IS LITERED TO		Cu	COPPER	PWC	POTABLE WATER CABINET		
$\geq$	FLEXIBLE RACEWAY (LIQUID-TIGHT AS NECESSARY)		CW	CLOCKWISE	R	RADIUS		
70.			CCW	COUNTER CLOCKWISE	(R)	RELOCATED		
7	HEAT TRACE		CRS	COLD ROLLED STEEL	RIDS	RAMP INFORMATION DISPLAY SYSTEM		
d	PHASE		DISC.	DISCONNECT	RGS	RIGID GALVANIZED STEEL		
Ψ	FRASE		DIA	DIAMETER	RMS	ROOT MEAN SQUARE		
	DACEWAY CONCEALED IN FLOOD OF LINDERCROUND		DX	DIRECT EXPANSION	SC	SCREW COVER		
	RACEWAY CONCEALED IN FLOOR OR UNDERGROUND		(E)	EXISTING	SD	SMOKE DETECTOR		
	EVDOOED BLOEIWAY		EMT	ELECTRICAL METALLIC TUBING	SOW	SUNLIGHT, OIL AND WATER RESISTANT, SIZE AS INDICATED		
	EXPOSED RACEWAY		LIMI		SS	STAINLESS STEEL		
_			FIDE	FUSE	SSFC	SOLID STATE FREQUENCY CONVERTER		
•	LIQUID TIGHT CABLE GRIP		FIDS	FLIGHT INFORMATION DISLPLAY SYSTEM	SWBD	SWITCHBOARD		
			FP	FIRE ALARM PULL STATION	TSP	TWISTED SHIELDED PAIR		
<b>■</b> WM	LIQUID TIGHT WIRE MESH STRAIN RELIEF		FLA	FULL LOAD AMPS	TYP	TYPICAL		
			FUS	FUSIBLE	UG	UNDERGROUND OR SUB-SURFACE		
<b>⊸</b>	CIRCUIT BREAKER W/ FRAME & TRIP RATINGS INDICATED			D GROUND		UNDERWRITERS LABORATORIES		
			GPU	GROUND POWER UNIT (400HZ OR 28VDC AS INDICATED)	UL			
T	DRY TYPE TRANSFORMER (UNLESS OTHERWISE NOTED)		GS	GROUND SERVICES (AIRCRAFT)	UPS	UN-INTERRUPTABLE POWER SUPPLY		
			GSE	GROUND SERVICES EQUIPMENT (AIRCRAFT)	V \/A	VOLT AMPERE		
<u>-</u>	GROUND CONNECTION		Н	HEIGHT	VA	VOLT AMPERE		
			HP	HORSEPOWER	W	WIDTH		
*	GROUNDING ELECTRODE		HZ	HERTZ	XFMR	TRANSFORMER		
_			IMC	INTERMEDIATE METAL CONDUIT	400HZ	400 HERTZ AIRCRAFT GROUND POWER		
#	MOTOR, WITH HP INDICATED		J	JUNCTION BOX				
_			JAN	JACKSON-MEDGAR WILEY EVERS INTERNATIONAL AIRPORT				
E	ELECTRIC UTILITY METER AS NOTED	CENEDAL NOTES.						
		GENERAL NOTES:		UIPMENT, TERMINATIONS. INSTALLATION DETAILS WITHIN THIS PACKAGE ARE PROVIDED AS				
	POTABLE WATER CABINET	SHOULD NOT BE CONSTRUED TO LIMIT THE CONTRACTOR'S WORK SHOWN THEREON. A			7. WORK THE V	AREAS AND STORAGE/LAY DOWN AREAS SHALL BE LIMITED TO THE RAMP AREA IN ICINITY OF THE SHUT DOWN GATE. DO NOT IMPACT OPERATIONS AT ADJACENT GATES.		
PW		GENERAL SUMMARY OF THE CONTRACTOR'S SCOPE OF WORK CAN BE SEEN IN THE SCHEDULE ON THIS DRAWING. CONTRACTOR SHALL BE RESPONSIBLE TO PROVIDE AND	A DESIGN INTENT ONLY. PROVIDE ALL INSTALLATION SERVICES, MATERIALS, ETC. AS NECESSARY TO INSTALL ACTUAL EQUIPMENT. ALL COSTS TO BE COVERED UNDER BASE BID.  5. ALL COMMISSIONING AND TESTING FOR INDICATED EQUIPMENT SHALL BE INCLUDED AS PART			8. PROVIDE APPROVED BARRICADES AROUND GATE AREAS DURING BRIDGE ERECTION AND		
PW					CRANE OPERATIONS.  9. SEE SPECIFICATIONS FOR ADDITIONAL COORDINATION INFORMATION OR DETAILS			
PW		INSTALL EQUIPMENT AS NECESSARY TO MEET THE DESIGN INTENT OF THIS PACKAGE AND TO		THIS CONTRACT.		PECIFICATIONS FOR ADDITIONAL COORDINATION INFORMATION OR DETAILS		
PW		INSTALL EQUIPMENT AS NECESSARY TO MEET THE DESIGN INTENT OF THIS PACKAGE AND TO PROVIDE AND INSTALL COMPLETE AND OPERABLE FINAL SYSTEMS.  2. EXISTING CONDITIONS SHOWN THROUGHOUT THIS PACKAGE ARE AN ACCUMULATION OF CAD	OF 6. TH (PE	E TERM LOADING BRIDGE MAY ALSO BE REFERRED TO AS PASSENGER BOARDING BRIDGE BB) THROUGHOUT THE PROJECT. EITHER TERM IS USED TO IDENTIFY THE EQUIPMENT		PECIFICATIONS FOR ADDITIONAL COORDINATION INFORMATION OR DETAILS.		
PW		INSTALL EQUIPMENT AS NECESSARY TO MEET THE DESIGN INTENT OF THIS PACKAGE AND TO PROVIDE AND INSTALL COMPLETE AND OPERABLE FINAL SYSTEMS.	OF 6. TH (PE US			PECIFICATIONS FOR ADDITIONAL COORDINATION INFORMATION OR DETAILS.		



COPYRIGHT
Allen & Hoshall
This document is proprietary to Allen &
Hoshall and shall not be reproduced or used
by others without prior written consent.

JMAA JET BRIDGE 2

JACKSON MUNICIPAL AIRPORT AUTHORITY 100 INTERNATIONAL DRIVE STE 300 JACKSON, MS 39298

SYMBOLS & ABBREVIATIONS

JOB NO: 62960

DATE: 08/18/21


DRAWN: BWW

CHECKED: CRB


CAD FILE:





PBB-0.1

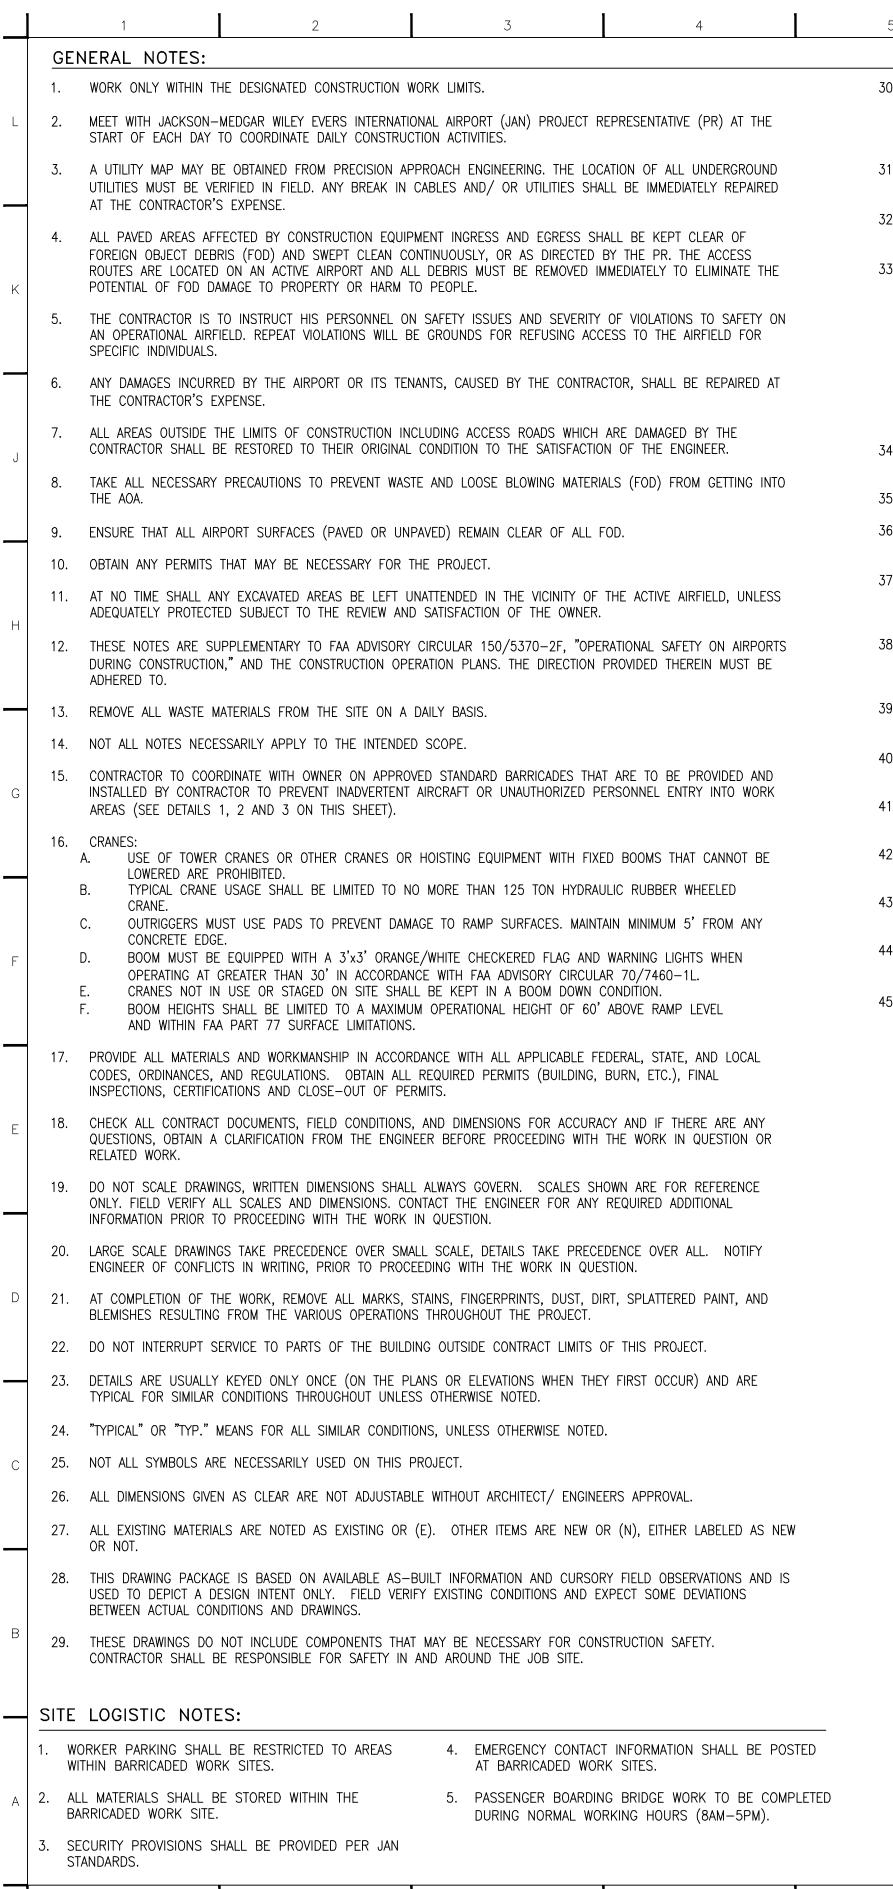



- 30. ALL WORK ASSOCIATED WITH THE REMOVAL AND INSTALLATION OF EQUIPMENT SHALL BE PERFORMED BY AN EXPERIENCED CONTRACTOR IN ACCORDANCE WITH THE SPECIFICATIONS. NO PROCEDURES, MEANS, OR METHODS INDICATED HEREIN ARE TO BE CONSTRUED AS TO LIMIT THE CONTRACTOR(S)' MEANS, METHODS, TECHNIQUES OR SEQUENCES TO CARRY OUT THE WORK.
- 31. ALL POWER OUTAGES TO BE COORDINATED WITH THE OWNER. POWER OUTAGE WILL LIKELY BE BETWEEN 12:00AM AND 5:00AM ONLY. FOLLOW AIRPORT POWER OUTAGE PROGRAM.
- 32. INSTALL ALL EQUIPMENT IN ACCORDANCE WITH MANUFACTURER'S INSTALLATION INSTRUCTIONS. ADVISE ENGINEER IF MANUFACTURER'S INSTRUCTIONS DEVIATE FROM DESIGN INTENT OR DETAILS.
- THE ENGINEER HAS MADE EVERY EFFORT TO SET FORTH IN THE BID DOCUMENTS THE COMPLETE SCOPE OF WORK FOR THE PROJECT. PROPOSERS ARE CAUTIONED THAT MINOR OMISSIONS AND DISCREPANCIES IN THE DOCUMENTS DO NOT EXCUSE OR EXCLUDE PROPOSERS FROM PROVIDING PROPOSAL PRICES TO COMPLETE THEIR RESPECTIVE PORTIONS OF THE PROJECT TO THE INTENT OF THESE DESIGN DOCUMENTS. IT IS THE RESPONSIBILITY OF THE PROPOSERS TO BRING ANY CONFLICTS, OMISSIONS OR DISCREPANCIES TO THE ATTENTION OF THE OWNER PRIOR TO THE SUBMITTAL OF THE PROPOSER'S BID. SUBMISSION OF BIDS OR OFFERS SHALL BE CONSIDERED AS PROPOSER'S EVIDENCE OF HAVING PERFORMED PROJECTS OF SIMILAR SIZE AND SCOPE AND AS PROPOSER'S ACCEPTANCE OF THESE TERMS AND CONDITIONS. AFTER EXECUTION OF THE CONTRACT, NO EXTRA CHARGE WILL BE ALLOWED FOR ITEMS OF WORK, WHERE SUCH ITEMS ARE CONCLUDED TO CONFORM WITH NORMAL CONSTRUCTION PRACTICES AND METHODS OF PROJECTS WITH SIMILAR SCOPES.
- 34. REPAIR ANY DAMAGE CAUSED OR CREATED BY CONTRACTOR TO (E) FACILITIES, EQUIPMENT, DEVICES, ETC. TO A PREVIOUSLY EXISTING CONDITION AT NO ADDITIONAL COST TO OWNER.
- 35. PROTECT ALL EQUIPMENT AND BRACKETS DURING MODIFICATIONS.
- 36. ADJUST LIMITS OF PBB SUCH AS NECESSARY TO PREVENT ANY DAMAGE TO NEWLY INSTALLED OR EXISTING EQUIPMENT.
- 37. WHEN WELDING ON THE BRIDGE, MAINTAIN A MAXIMUM OF 18" BETWEEN THE ARCING ELECTRODE AND THE GROUNDING CONNECTION, SO AS TO ENSURE THAT WELDING CURRENT FLOWS IN THE ACTUAL MATERIAL BEING WELDED ONLY.
- 38. NOT ALL SYSTEMS AND SERVICES SHOWN FOR CLARITY. ALL MAJOR POWER CIRCUITS SHOWN. DISCONNECT, EXTEND, REMOVE, DISCARD, REINSTALL, AND CONNECT AS REQUIRED TELEPHONE SERVICE, SECURITY DEVICES, TEMP SENSORS, COMMUNICATIONS BUSSES, ETCETERA FOR A COMPLETE AND OPERATIONAL INSTALLATION.
- 39. ALL PBB INTERIOR INSTALLATIONS ON WALL PANELS SHALL UTILIZE INSTALLATION METHODS THAT DO NOT REQUIRE PENETRATION OF WALL BOARDS WITH SCREWS OR THE LIKE.
- 40. FOR ANY EQUIPMENT THAT IS TO BE REMOVED & REINSTALLED, PROVIDE AND INSTALL (N) MOUNTING BRACKETS AS NECESSARY.
- 41. PREPARE, PATCH, PRIME AND PAINT AS NECESSARY ALL POINTS OF DEMOLITION TO MATCH SURROUNDING
- 42. ALL EQUIPMENT INSTALLED OR RE-INSTALLED ON PBB SHALL BE PAINTED TO MATCH THE PBB ON WHICH IT IS INSTALLED.
- 43. PROVIDE & INSTALL SECURE WEATHERPROOFING ON ANY WALKWAYS OR BUILDING ELEMENTS EXPOSED DUE TO CONSTRUCTION ACTIVITIES AS NECESSARY.
- 44. DURING PERIODS WHEN PBB IS REMOVED FROM GATE, SECURE TERMINAL DOOR & PROVIDE & INSTALL TEMPORARY SIGNAGE ON DOOR INTERIORS WHICH STATES "AREA UNDER CONSTRUCTION" AND "NOT AN EXIT."
- 45. ALL (N) EQUIPMENT IDENTIFIED HEREIN REPRESENTS A DESIGN INTENT ONLY. MANUFACTURER AND CONTRACTOR SHALL COORDINATE AS NECESSARY TO DESIGN MANUFACTURE AND INSTALL IDENTIFIED EQUIPMENT IN A MANNER TO COORDINATE WITH ALL FIELD CONDITIONS AND OTHER IDENTIFIED EQUIPMENT WHETHER EXISTING (E) OR NEW (N).

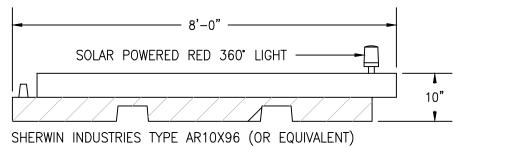

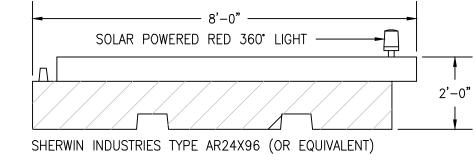

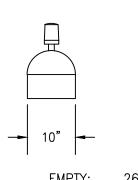


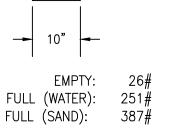


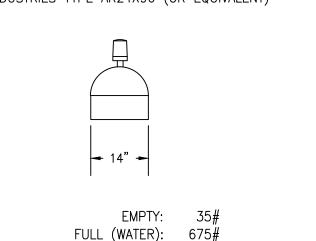

### NOTES:


- 1. PROVIDE AND INSTALL PER FAA ADVISORY CIRCULAR 150/5370-2F, AND JAN REQUIREMENTS.
- 2. LIGHTS SHALL HAVE A MINIMUM EFFECTIVE INTENSITY OF 6 CANDELA.
- 3. POLYETHYLENE PLASTIC ALTERNATE ORANGE/WHITE FILL WITH WATER OR SAND WEIGHT.

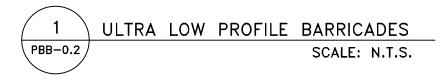


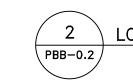

LOW PROFILE BARRICADES

SCALE: N.T.S.

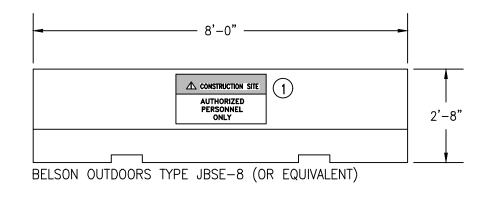


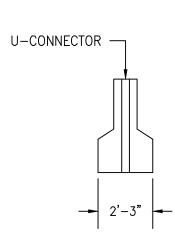

### NOTES:

- 1. PROVIDE AND INSTALL PER FAA ADVISORY CIRCULAR 150/5370-2F, AND JAN REQUIREMENTS.
- 2. CONCRETE BARRIER WEIGHT: 3,575LBS



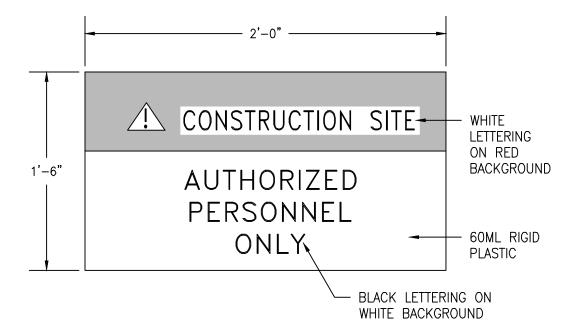

# PASSENGER BOARDING BRIDGE GENERAL NOTES

Allen & Hoshall, P.L.L.C. Michel Lebel, Architect 1675 Lakeland Drive, Suite 207 Jackson, Mississippi 39216

601 977 8993 fax 601 949 4344

COPYRIGHT Allen & Hoshall

This document is proprietary to Allen & Hoshall and shall not be reproduced or used

by others without prior written consent.

JACKSON MUNICIPAL AIRPORT AUTHORITY

100 INTERNATIONAL DRIVE STE 300

JMAA JET BRIDGE 2

JOB NO: 62960 DATE: 08/18/21 DRAWN: **BWW** 

JACKSON, MS 39298


CHECKED: CRB



PBB-0.2

LEGEND NOTES:

(1) CONSTRUCTION SITE SIGNAGE SHALL BE PERMANENTLY ATTACHED TO EACH CONCRETE BARRICADE AND SHALL BE ORIENTED TO FACE THE OUTSIDE OF THE AREA. USE SETON ITEM # 94149 OR APPROVED EQUAL.

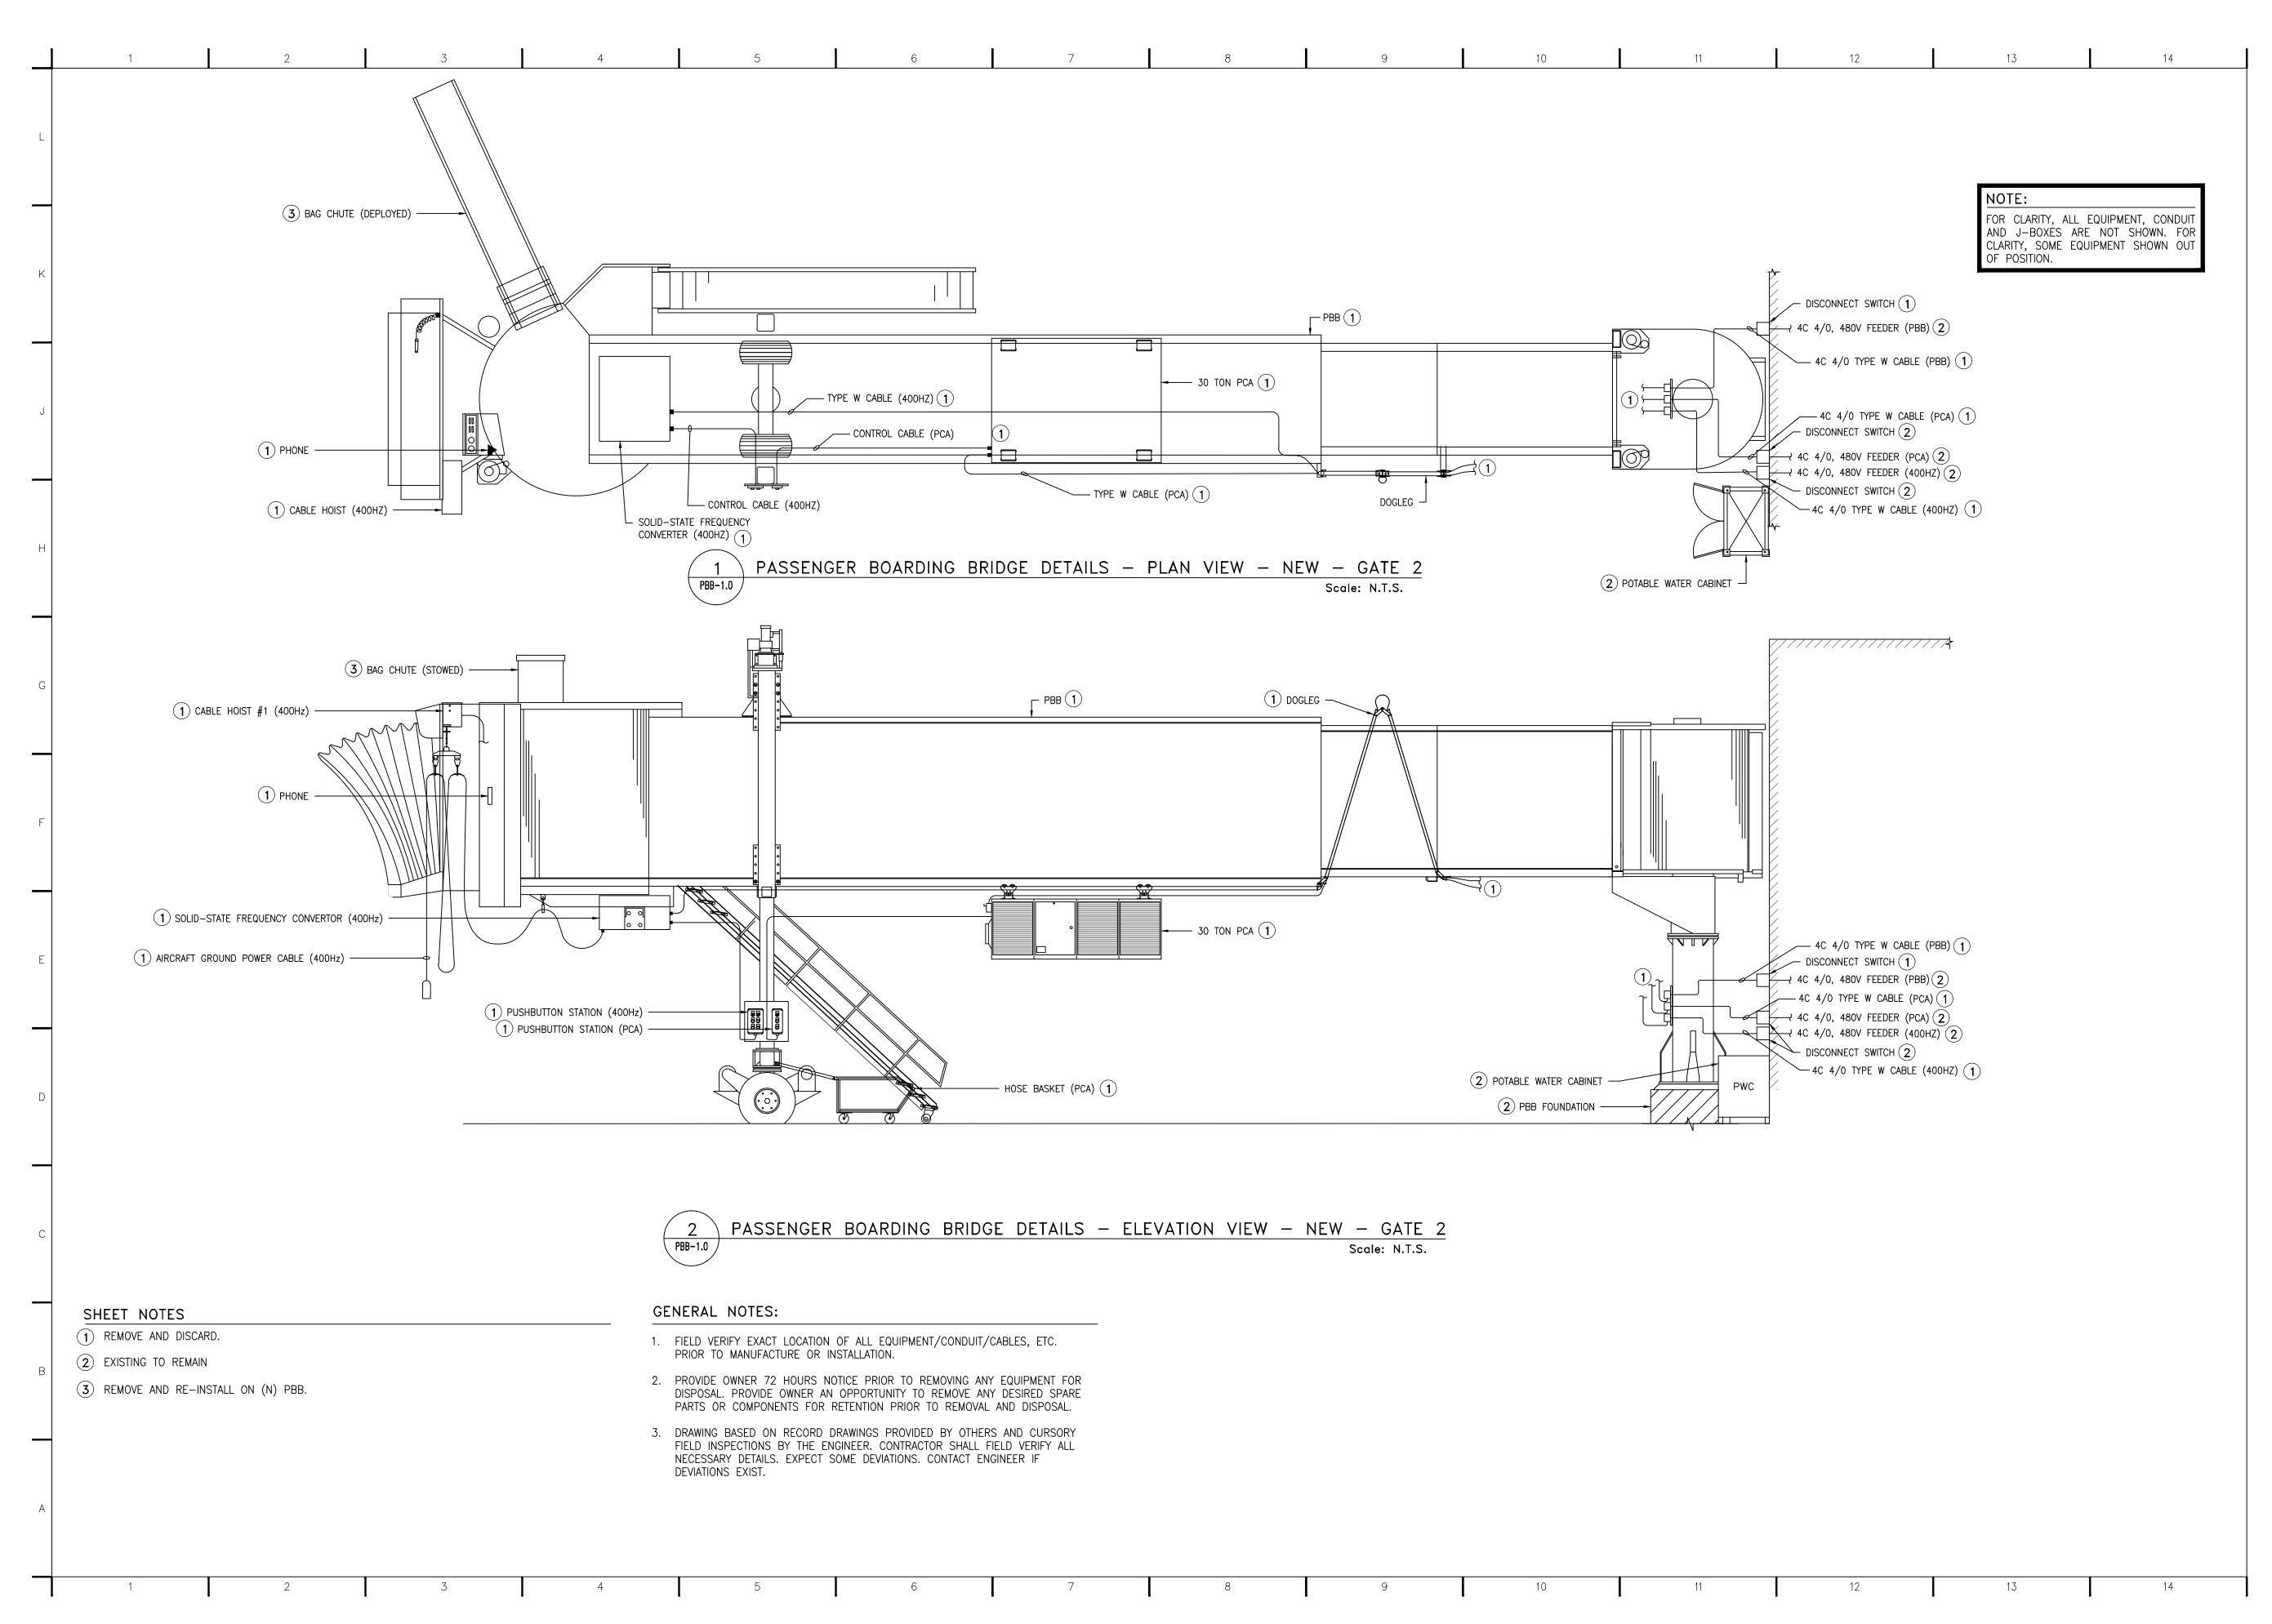



COPYRIGHT
Allen & Hoshall
This document is proprietary to Allen &
Hoshall and shall not be reproduced or used
by others without prior written consent.

JMAA JET BRIDGE 2

JACKSON MUNICIPAL AIRPORT AUTHORITY 100 INTERNATIONAL DRIVE STE 300 JACKSON, MS 39298

EXISTING PASSENGER BOARDING BRIDGE LAYOUT - GATE 2

JOB NO: 62960

DATE: 08/18/21


DRAWN: BWW

CHECKED: CRB

CAD FILE:



PBB-1.0

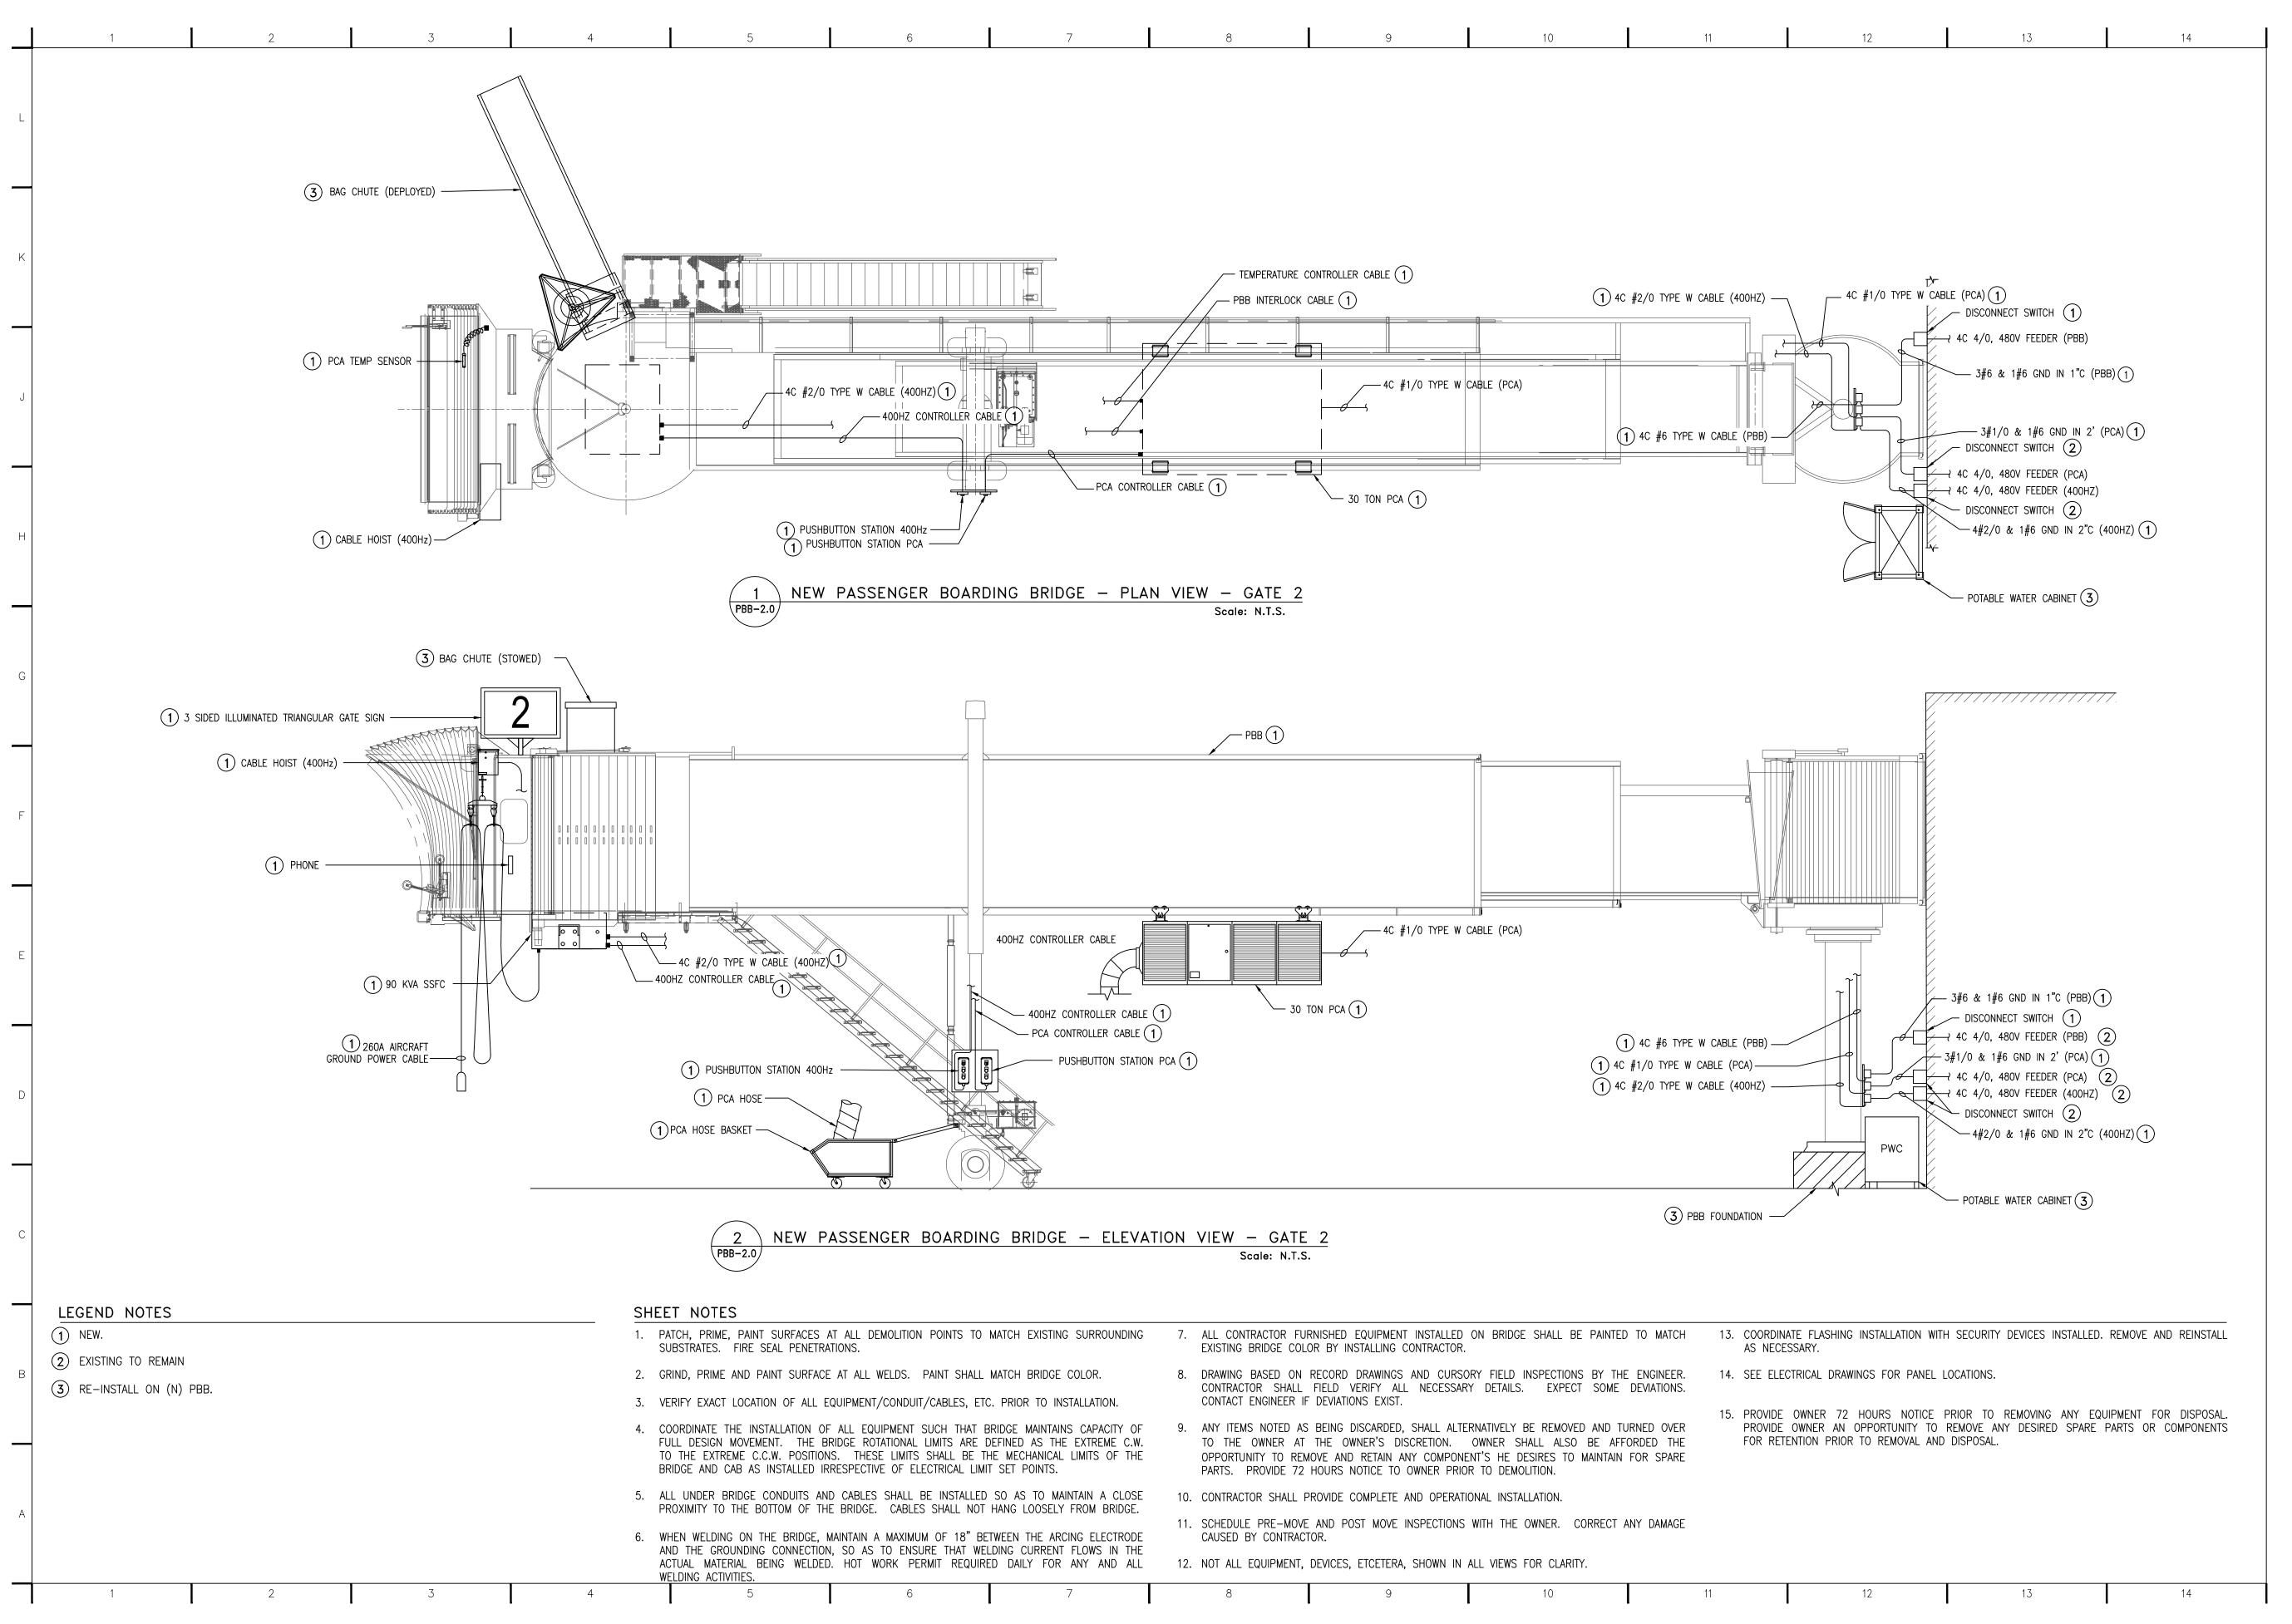



COPYRIGHT

Allen & Hoshall

This document is proprietary to Allen &

Hoshall and shall not be reproduced or used

by others without prior written consent.

JMAA JET BRIDGE 2

JACKSON MUNICIPAL AIRPORT AUTHORITY 100 INTERNATIONAL DRIVE STE 300 JACKSON, MS 39298

NEW PASSENGER BOARDING BRIDGE LAYOUT - GATE 2

JOB NO: 62960

DATE: 08/18/21


DRAWN: BWW

CHECKED: CRB

CAD FILE:



PBB-2.0

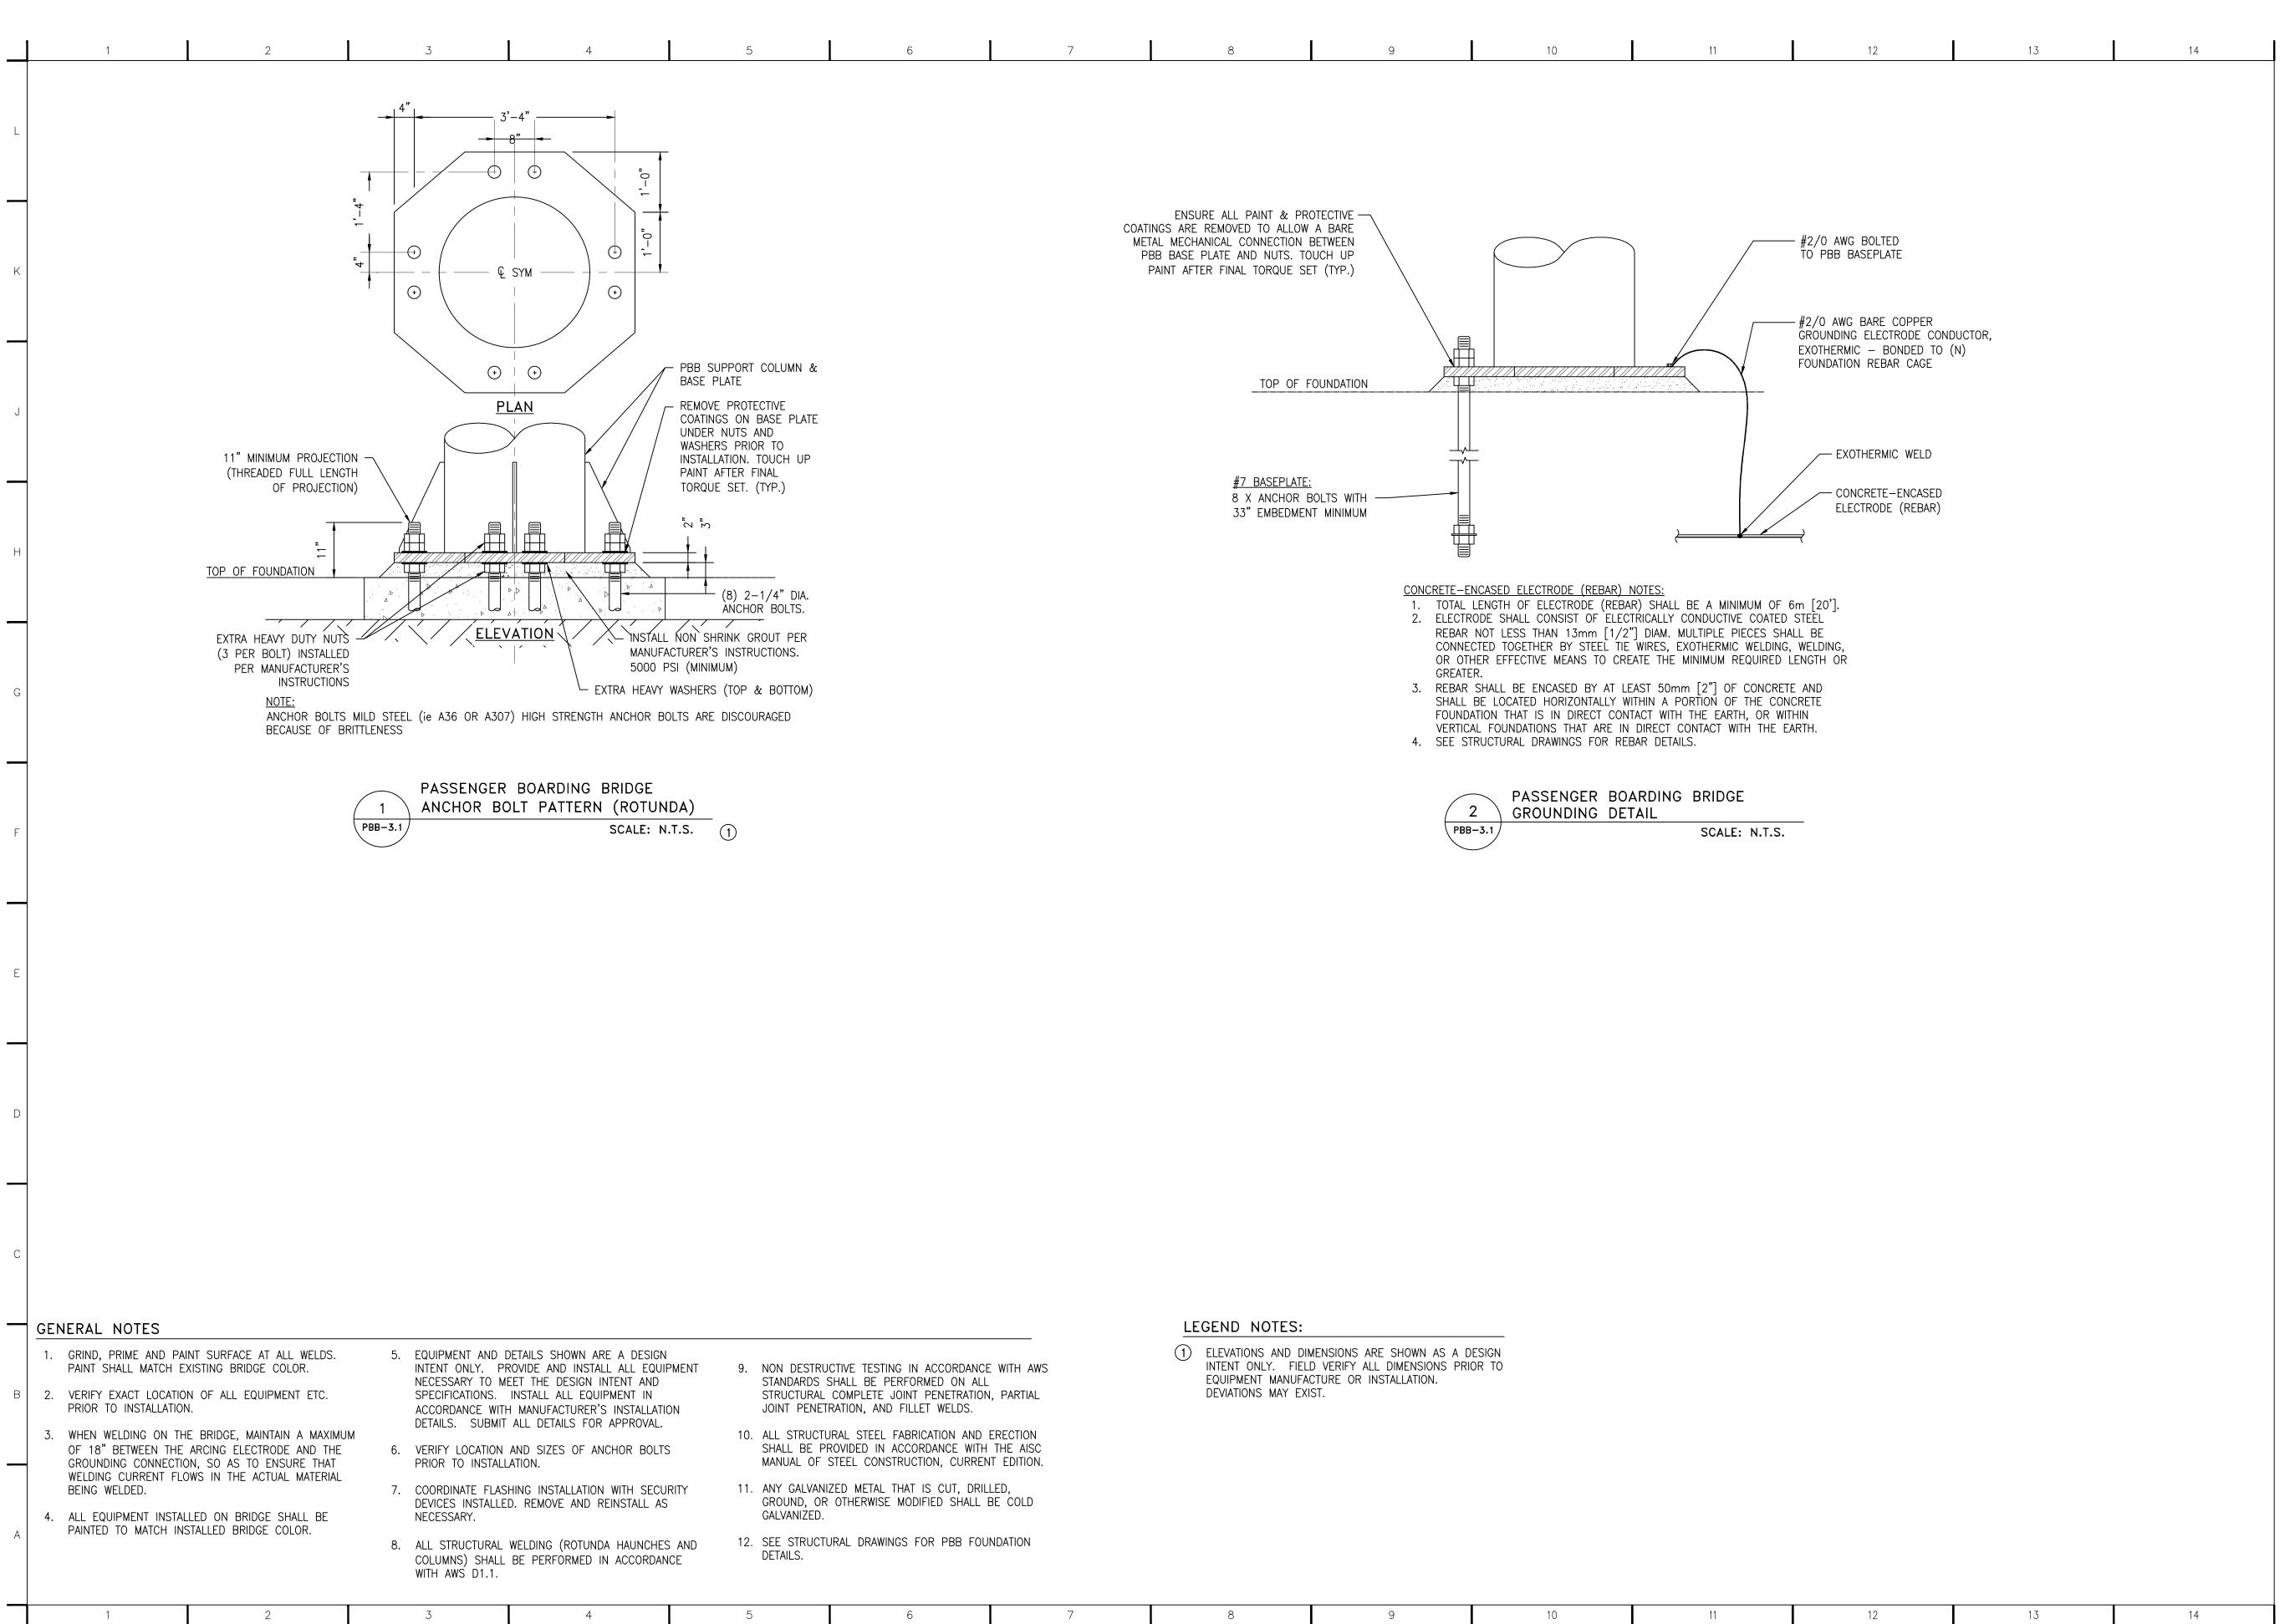



COPYRIGHT
Allen & Hoshall
This document is proprietary to Allen &
Hoshall and shall not be reproduced or used
by others without prior written consent.

JMAA JET BRIDGE 2


JACKSON MUNICIPAL AIRPORT AUTHORITY 100 INTERNATIONAL DRIVE STE 300 JACKSON, MS 39298

PASSENGER BOARDING BRIDGE DETAILS
- PART ONE


JOB NO: 62960
DATE: 08/18/21
DRAWN: BWW
CHECKED: CRB

CAD FILE:



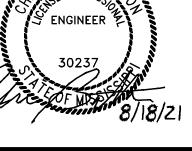

PBB-3.1

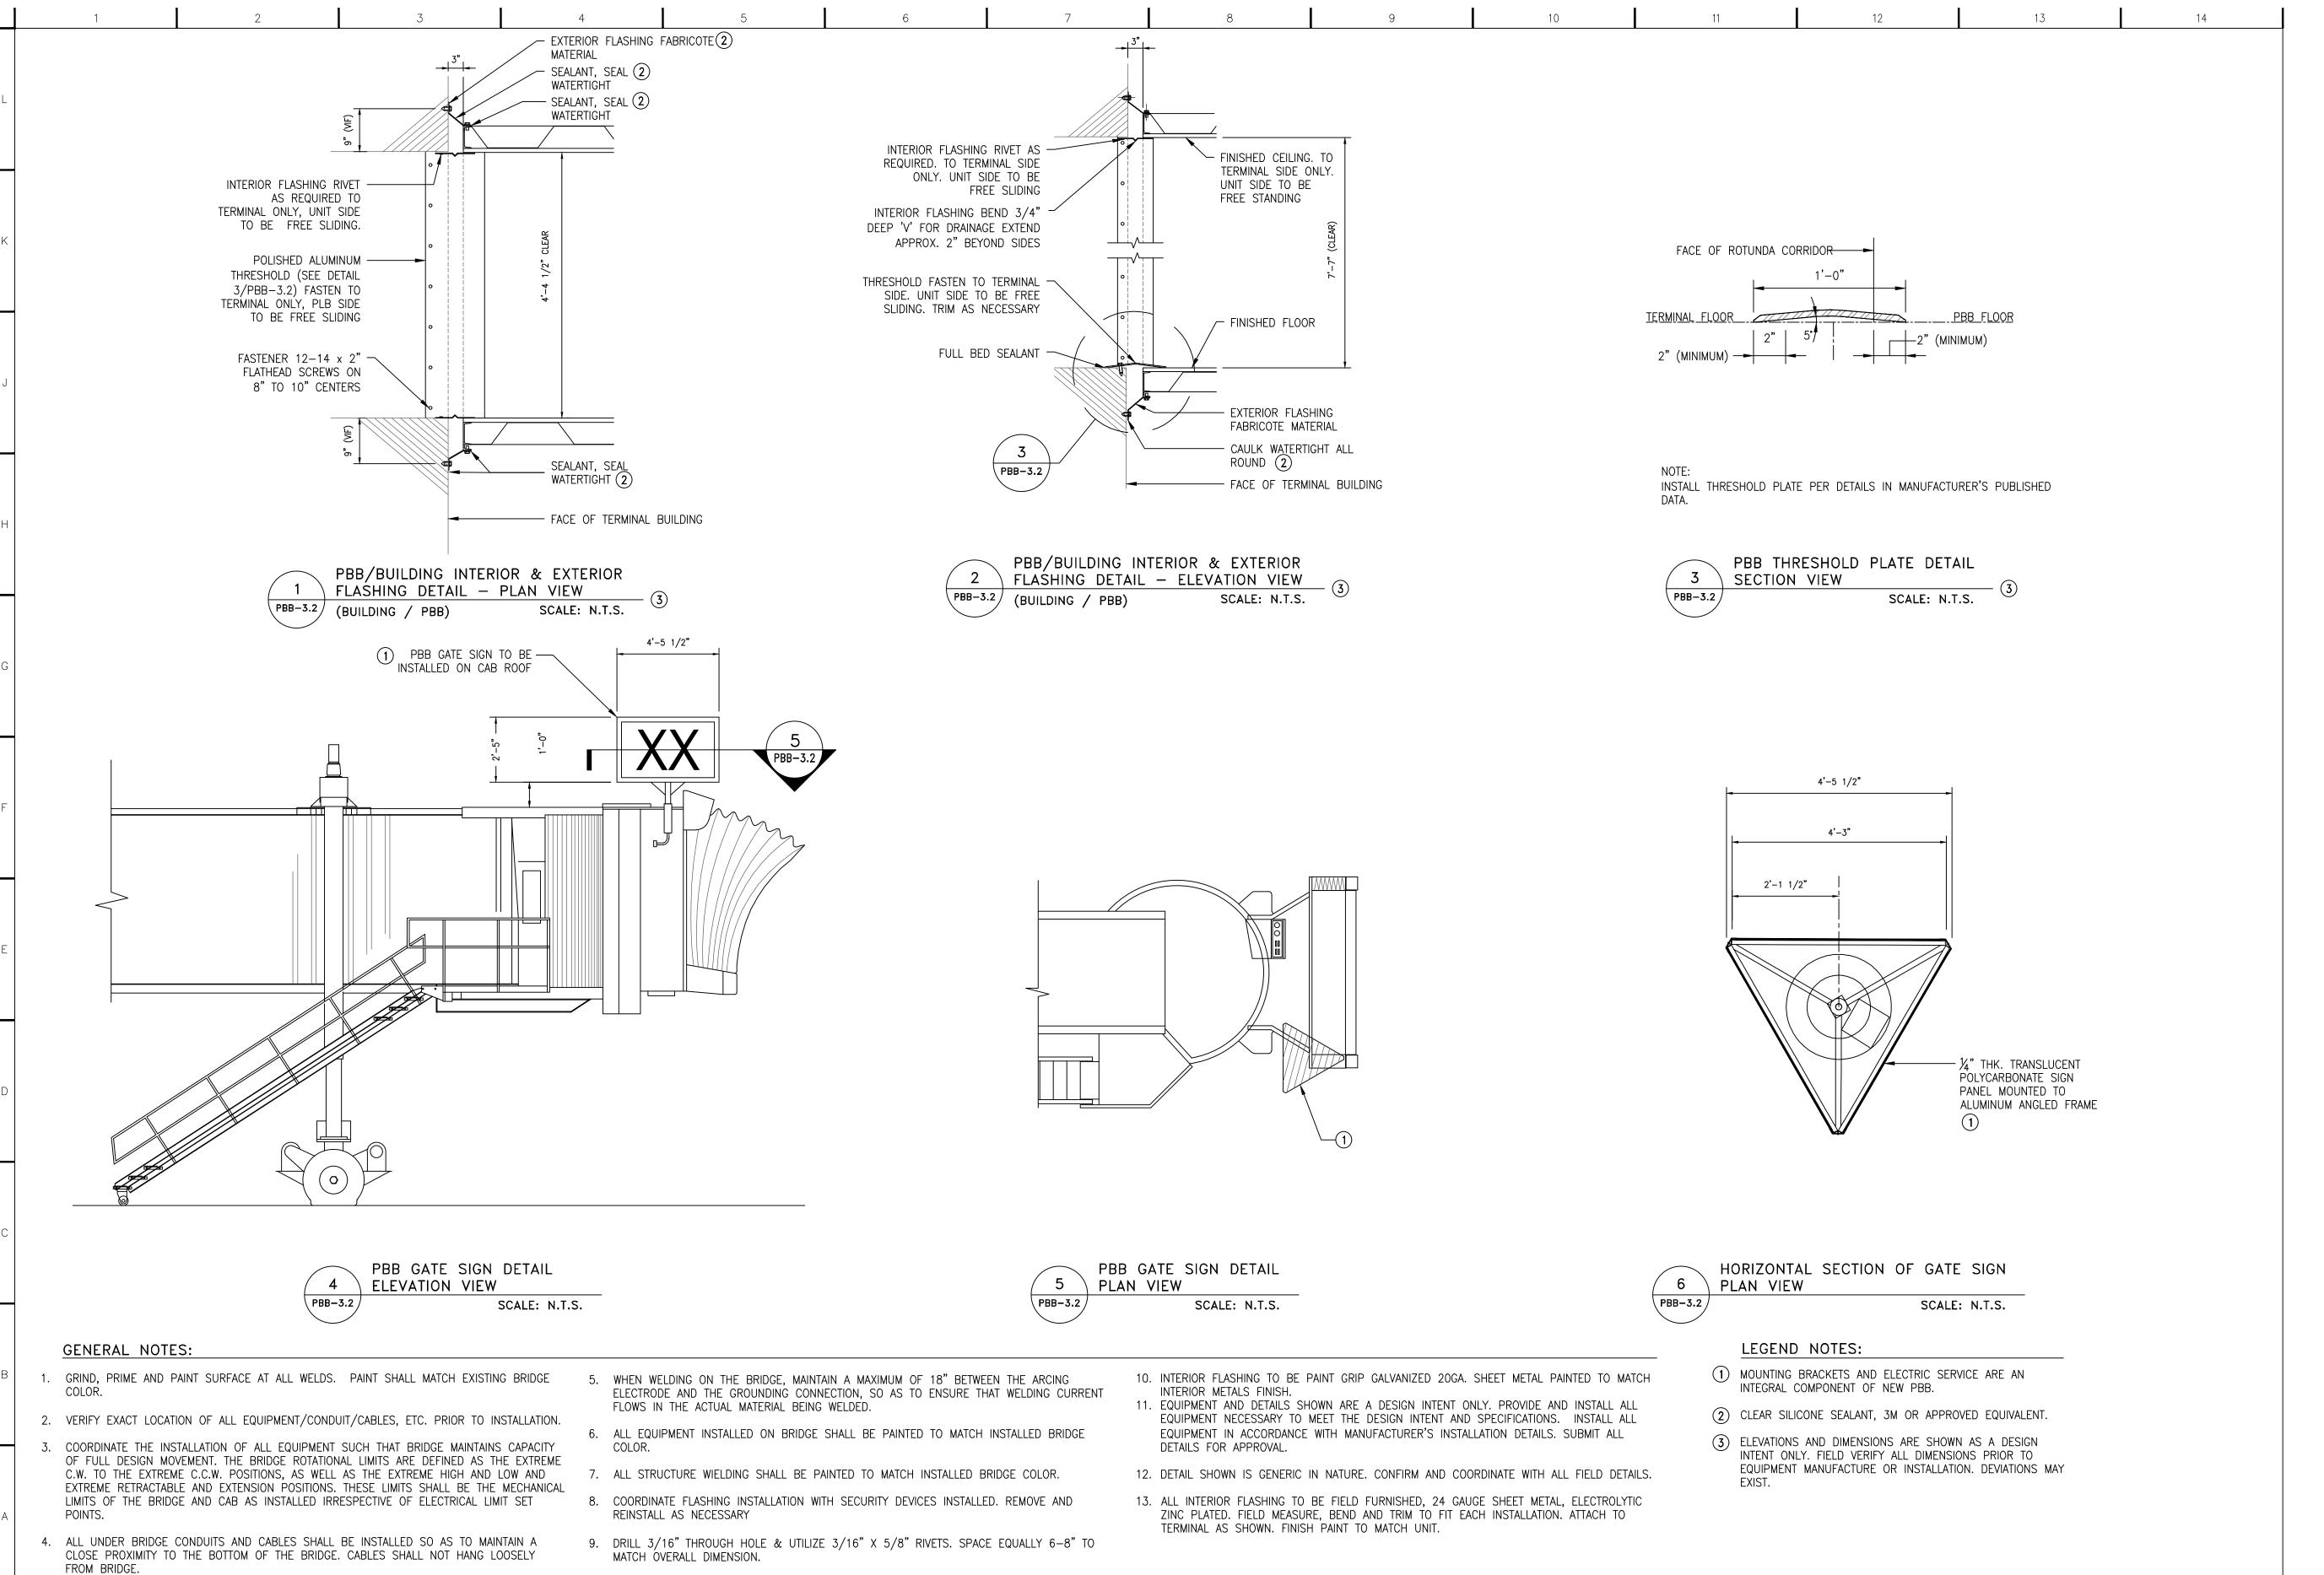



COPYRIGHT

Allen & Hoshall

This document is proprietary to Allen &

Hoshall and shall not be reproduced or used
by others without prior written consent.


JMAA JET BRIDGE 2

JACKSON MUNICIPAL AIRPORT AUTHORITY 100 INTERNATIONAL DRIVE STE 300 JACKSON, MS 39298


PASSENGER BOARDING BRIDGE DETAILS
- PART TWO

JOB NO: 62960
DATE: 08/18/21
DRAWN: **BWW** 

CHECKED: **CRB** CAD FILE:

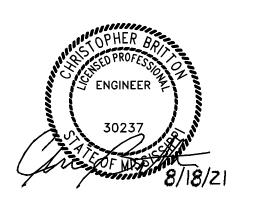

**PBB-3.2** 

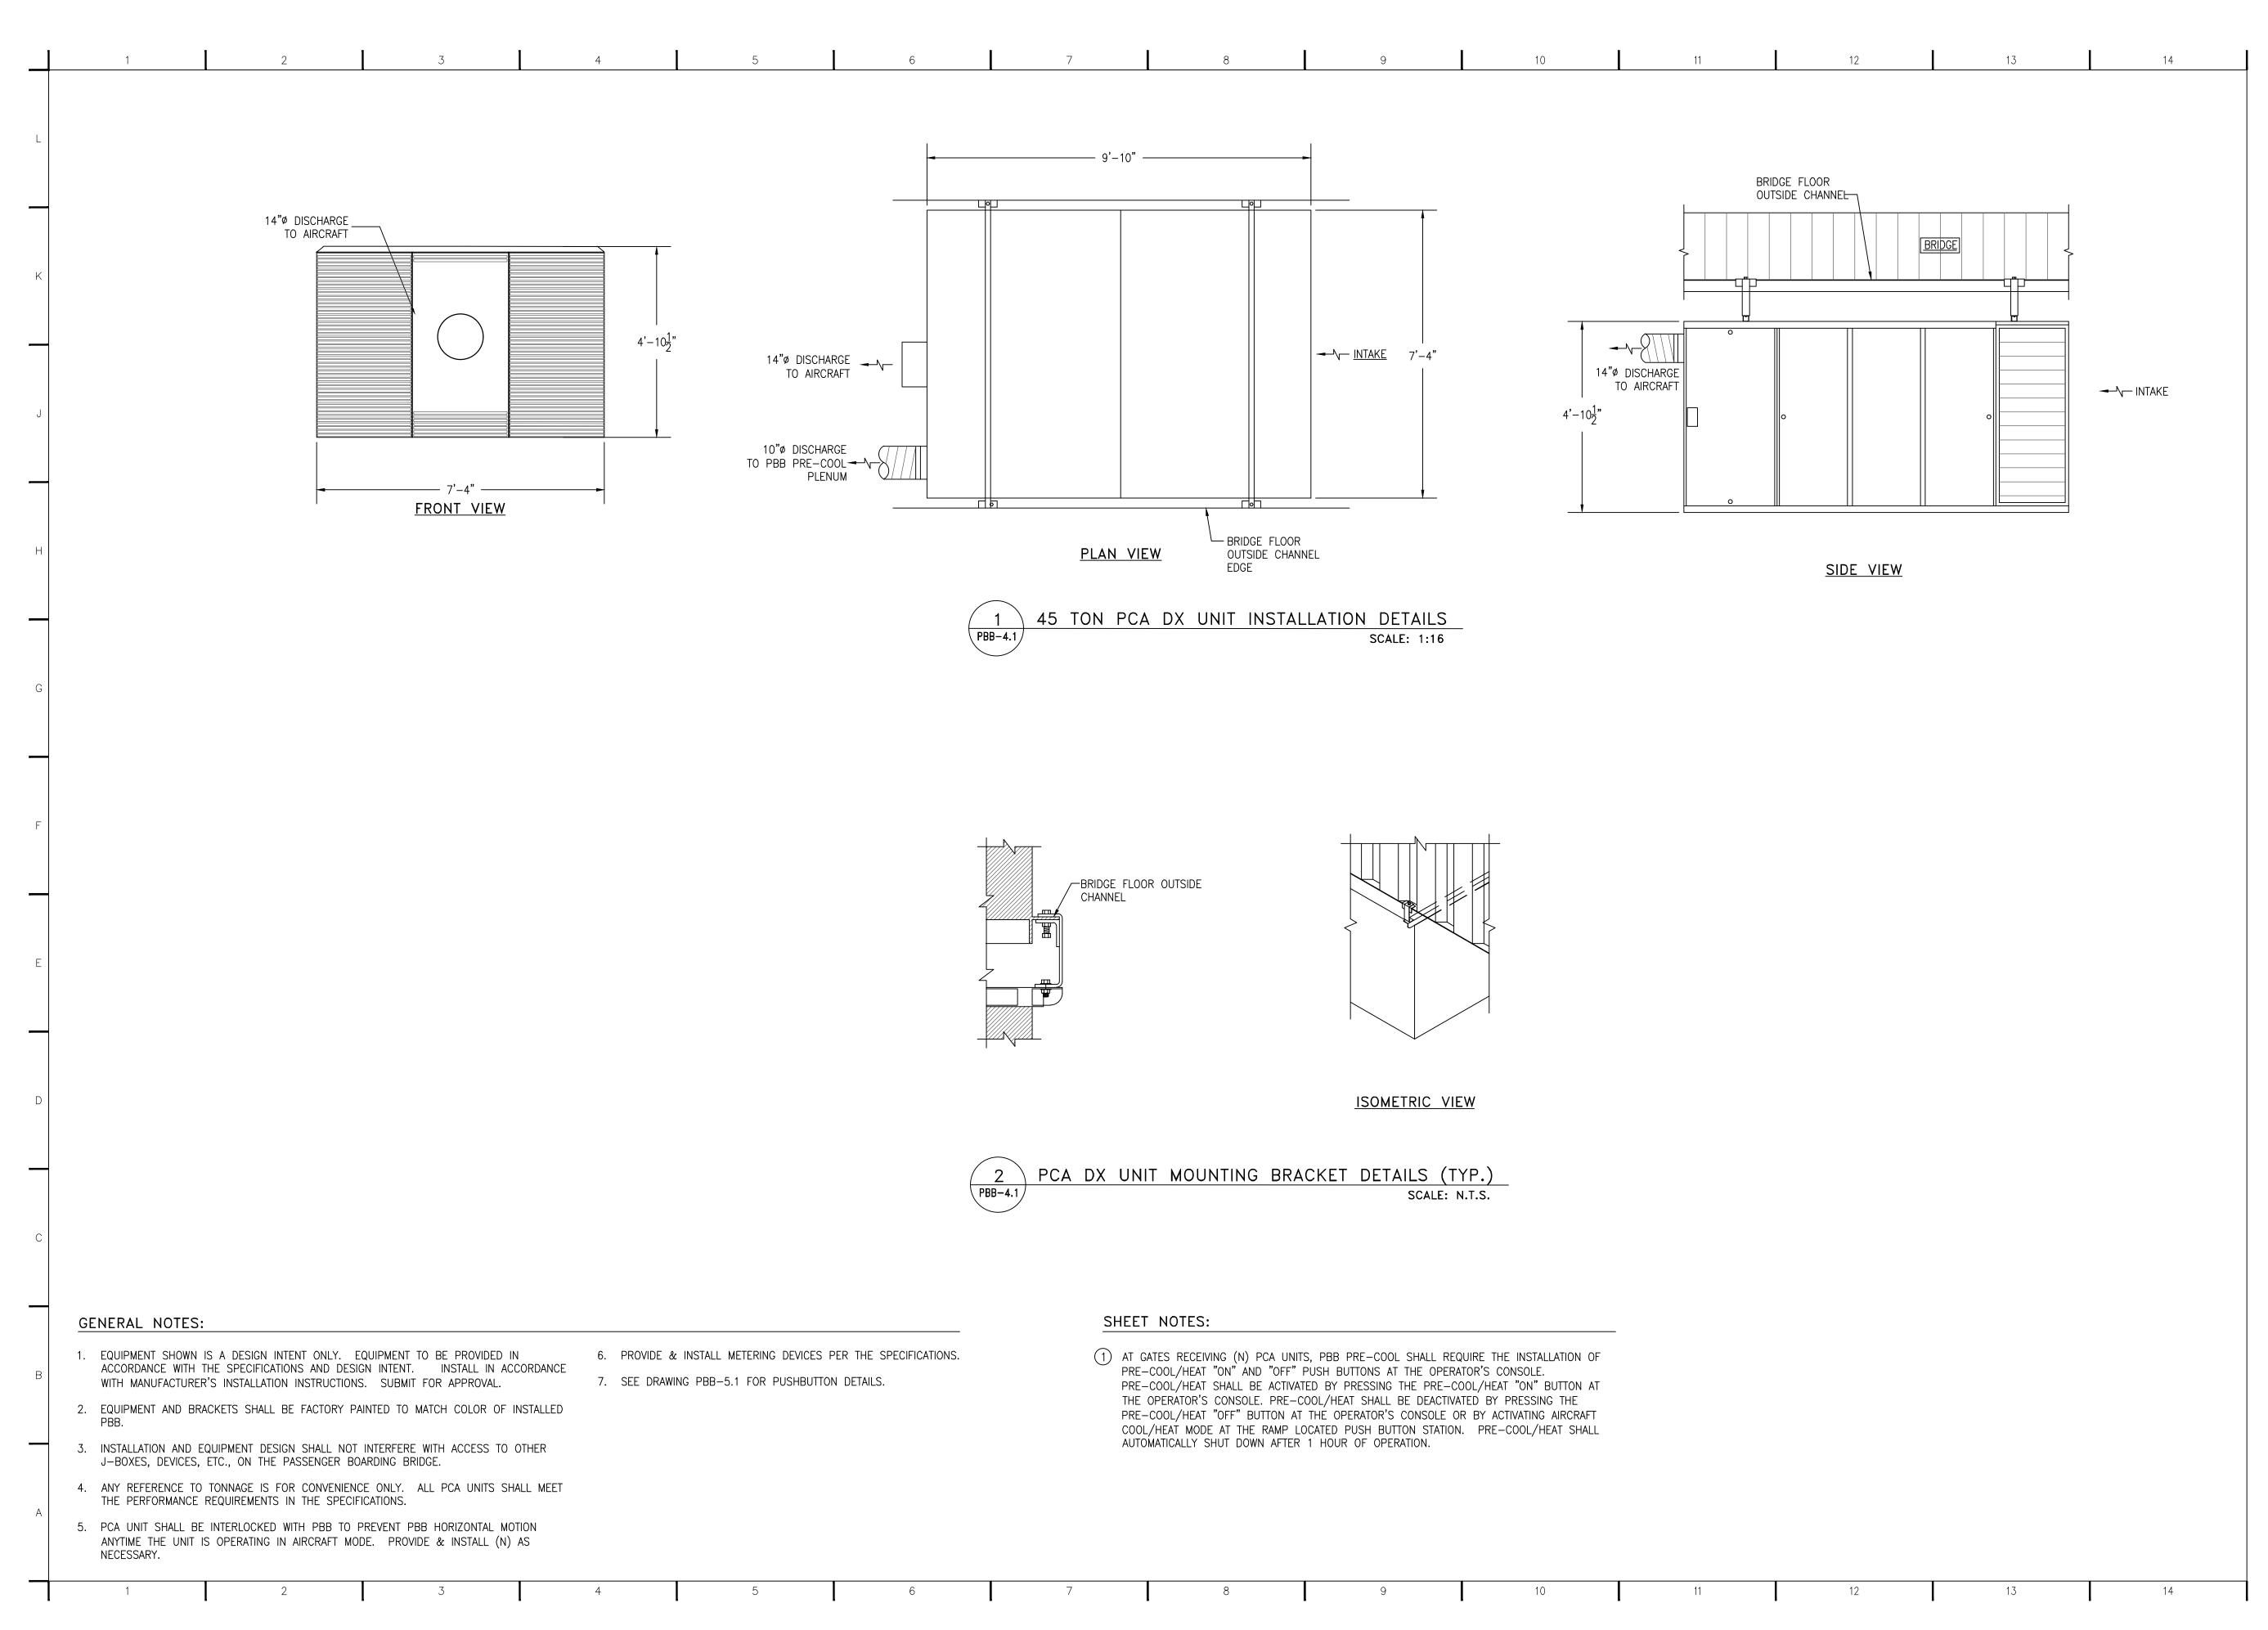



COPYRIGHT
Allen & Hoshall
This document is proprietary to Allen &
Hoshall and shall not be reproduced or used
by others without prior written consent.

JMAA JET BRIDGE 2

JACKSON MUNICIPAL AIRPORT AUTHORITY 100 INTERNATIONAL DRIVE STE 300 Jackson, ms 39298

NEW PCA DETAILS - PART ONE

JOB NO: 62960

DATE: 08/18/21


DRAWN: BWW

CHECKED: CRB

CAD FILE:



PBB-4.1

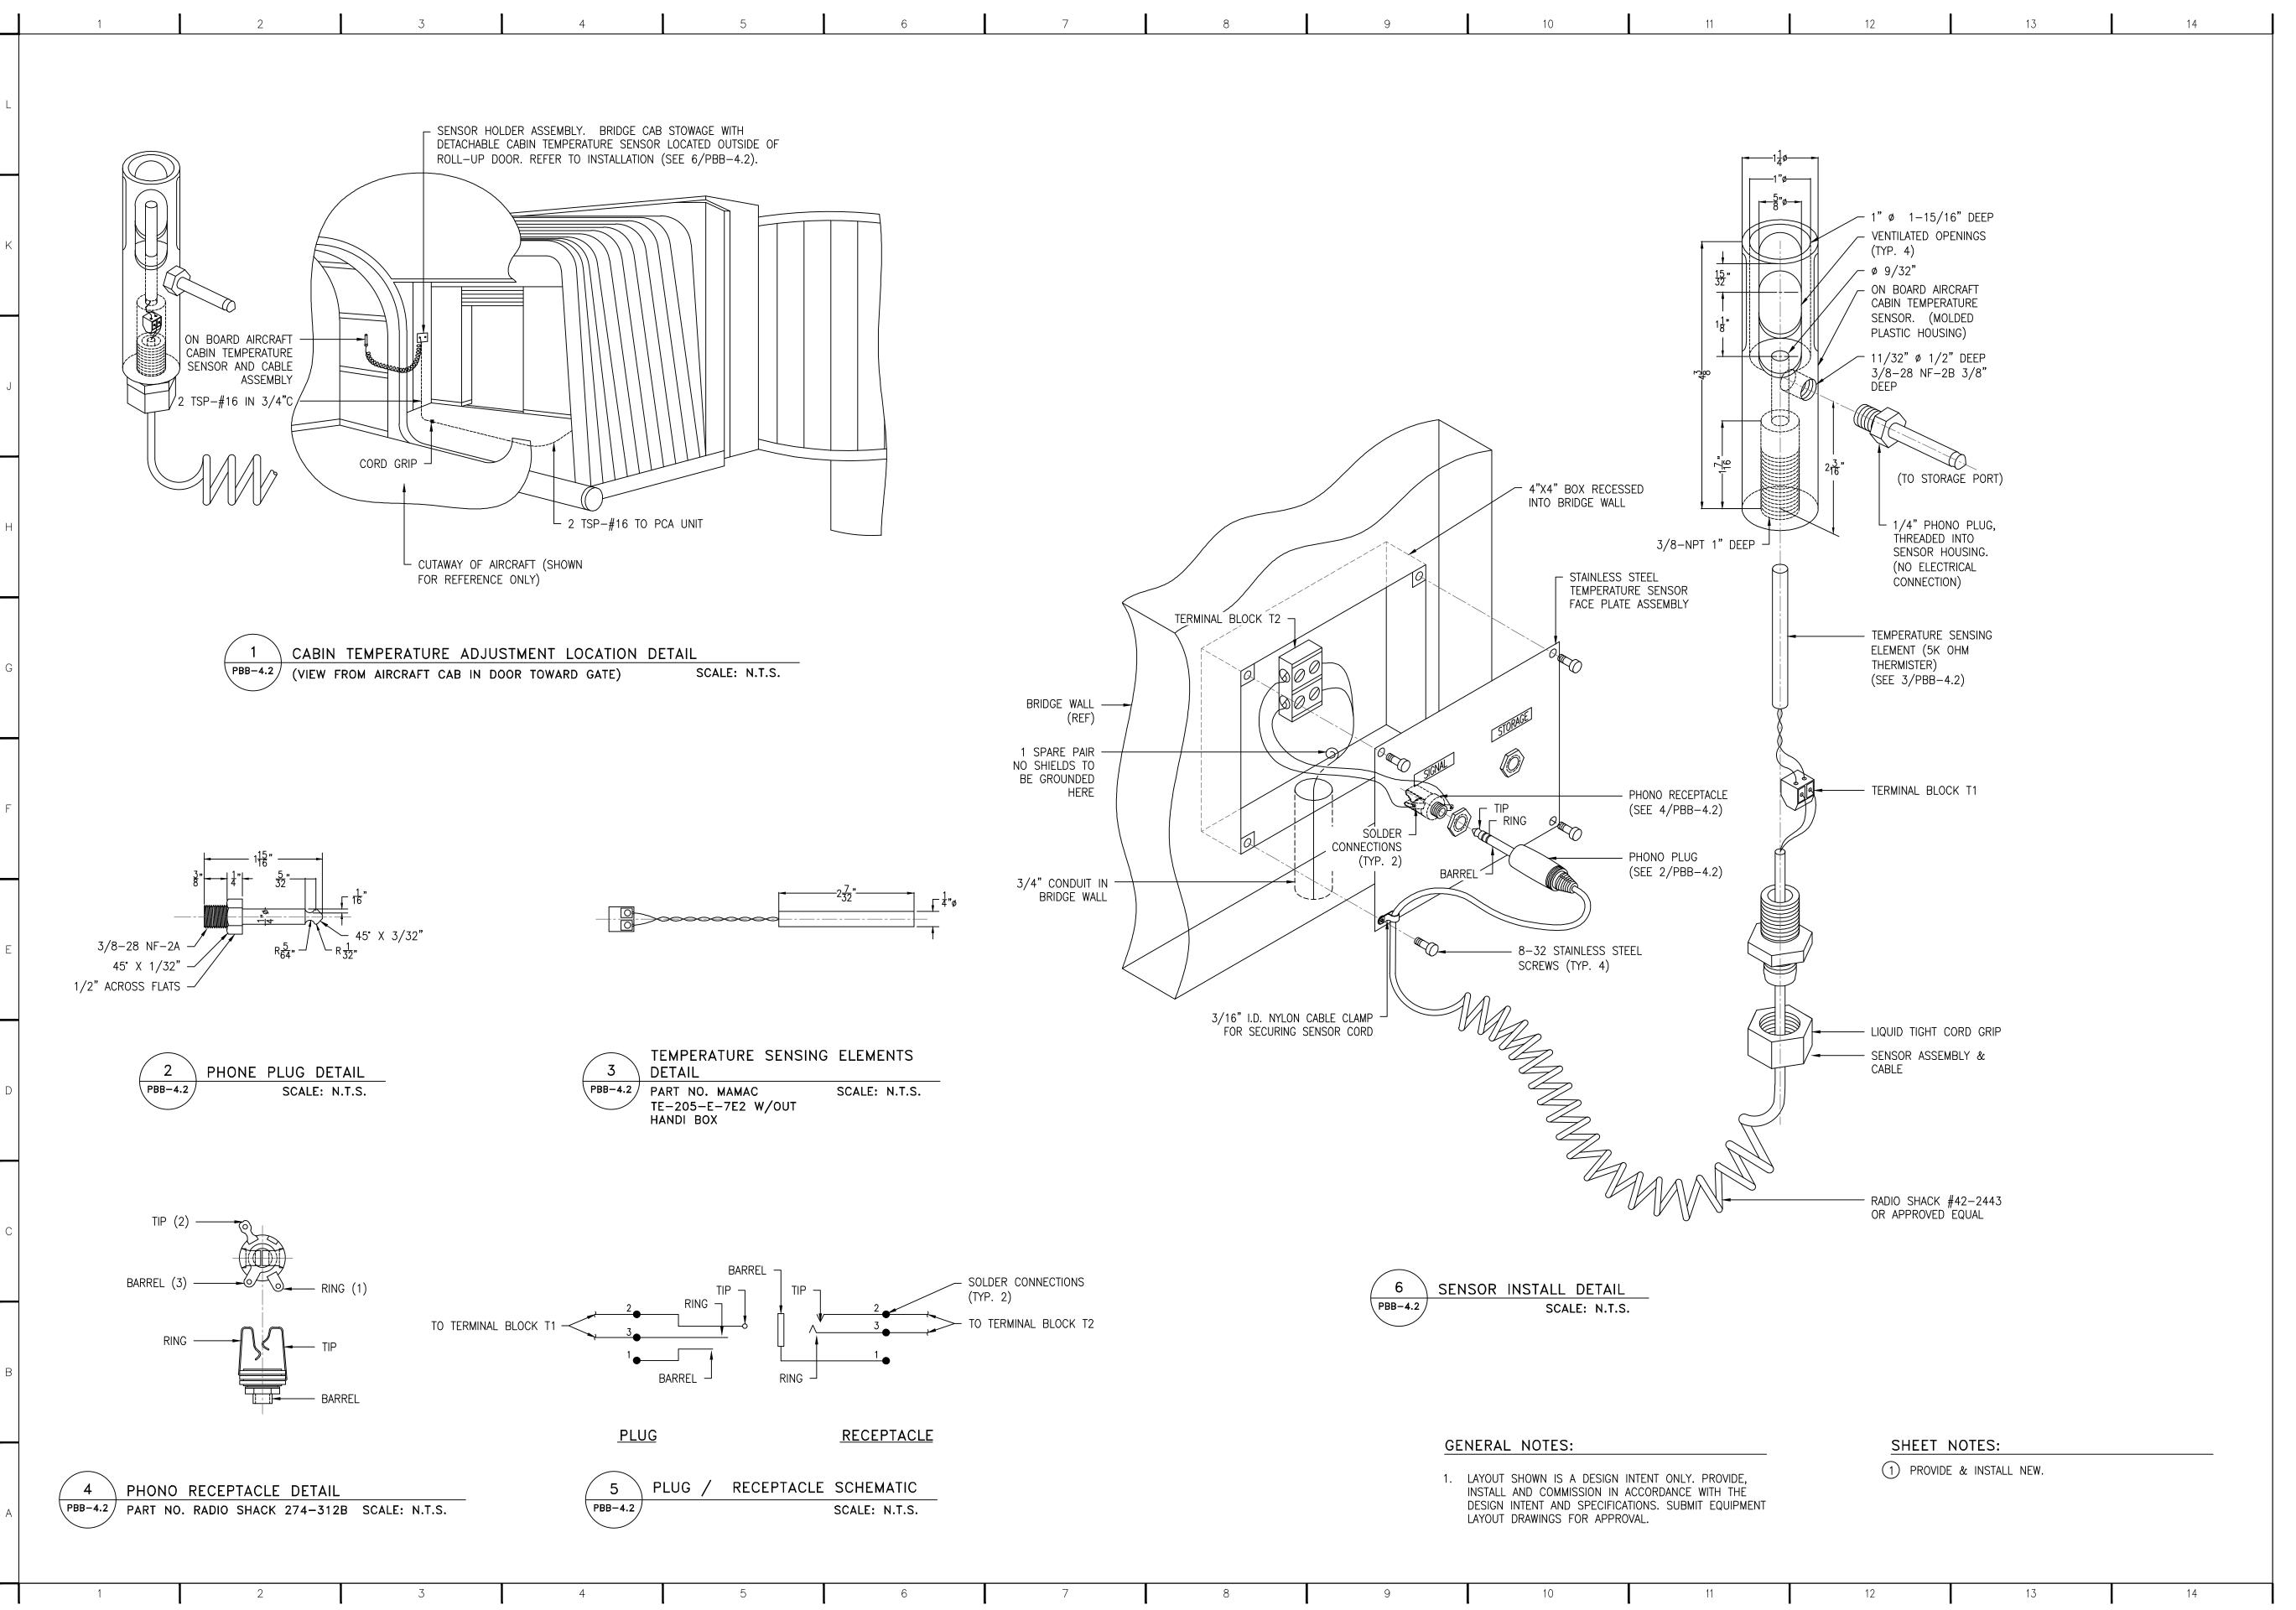



COPYRIGHT
Allen & Hoshall
This document is proprietary to Allen &
Hoshall and shall not be reproduced or used
by others without prior written consent.

JMAA JET BRIDGE 2

JACKSON MUNICIPAL AIRPORT AUTHORITY 100 INTERNATIONAL DRIVE STE 300 JACKSON, MS 39298

NEW PCA DETAILS - PART TWO

JOB NO: 62960

DATE: 08/18/21


DRAWN: BWW

CHECKED: CRB

CAD FILE:



PBB-4.2

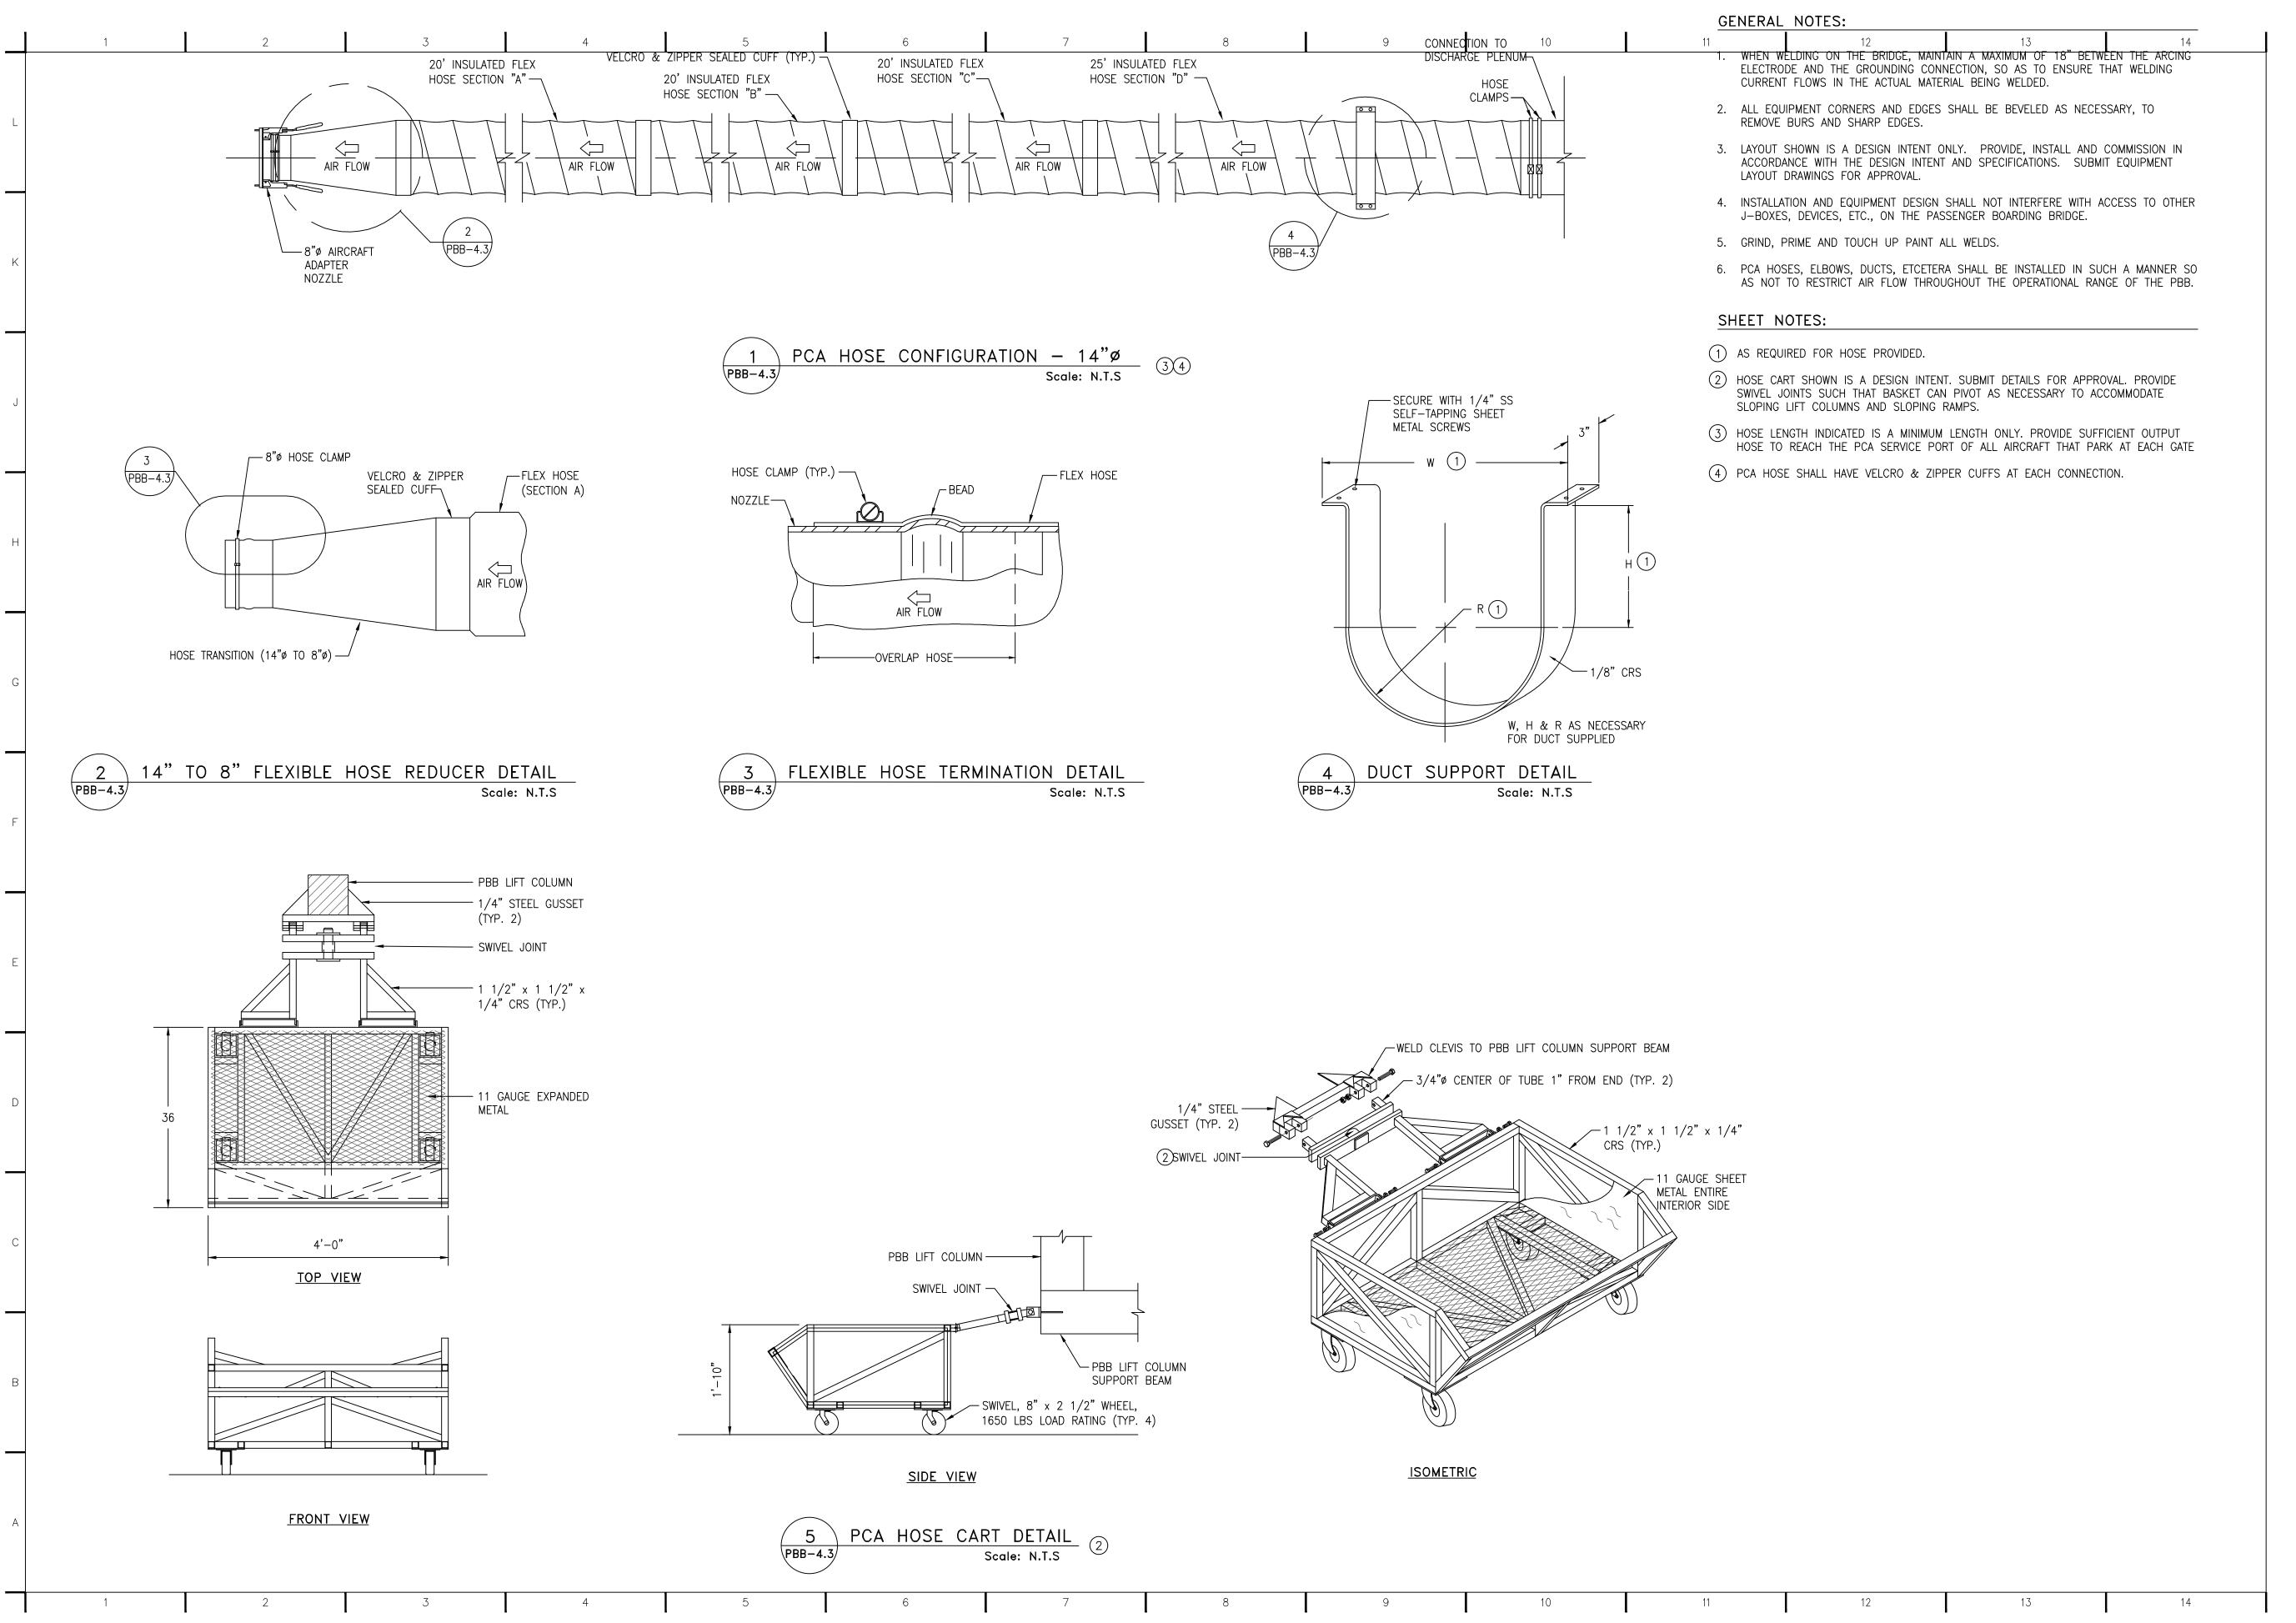



COPYRIGHT

Allen & Hoshall

This document is proprietary to Allen &

Hoshall and shall not be reproduced or used

by others without prior written consent.

JMAA JET BRIDGE 2

JACKSON MUNICIPAL AIRPORT AUTHORITY 100 INTERNATIONAL DRIVE STE 300 JACKSON, MS 39298

NEW PCA DETAILS - PART THREE

JOB NO: 62960

DATE: 08/18/21


DRAWN: BWW

CHECKED: CRB

CAD FILE:



PBB-4.3

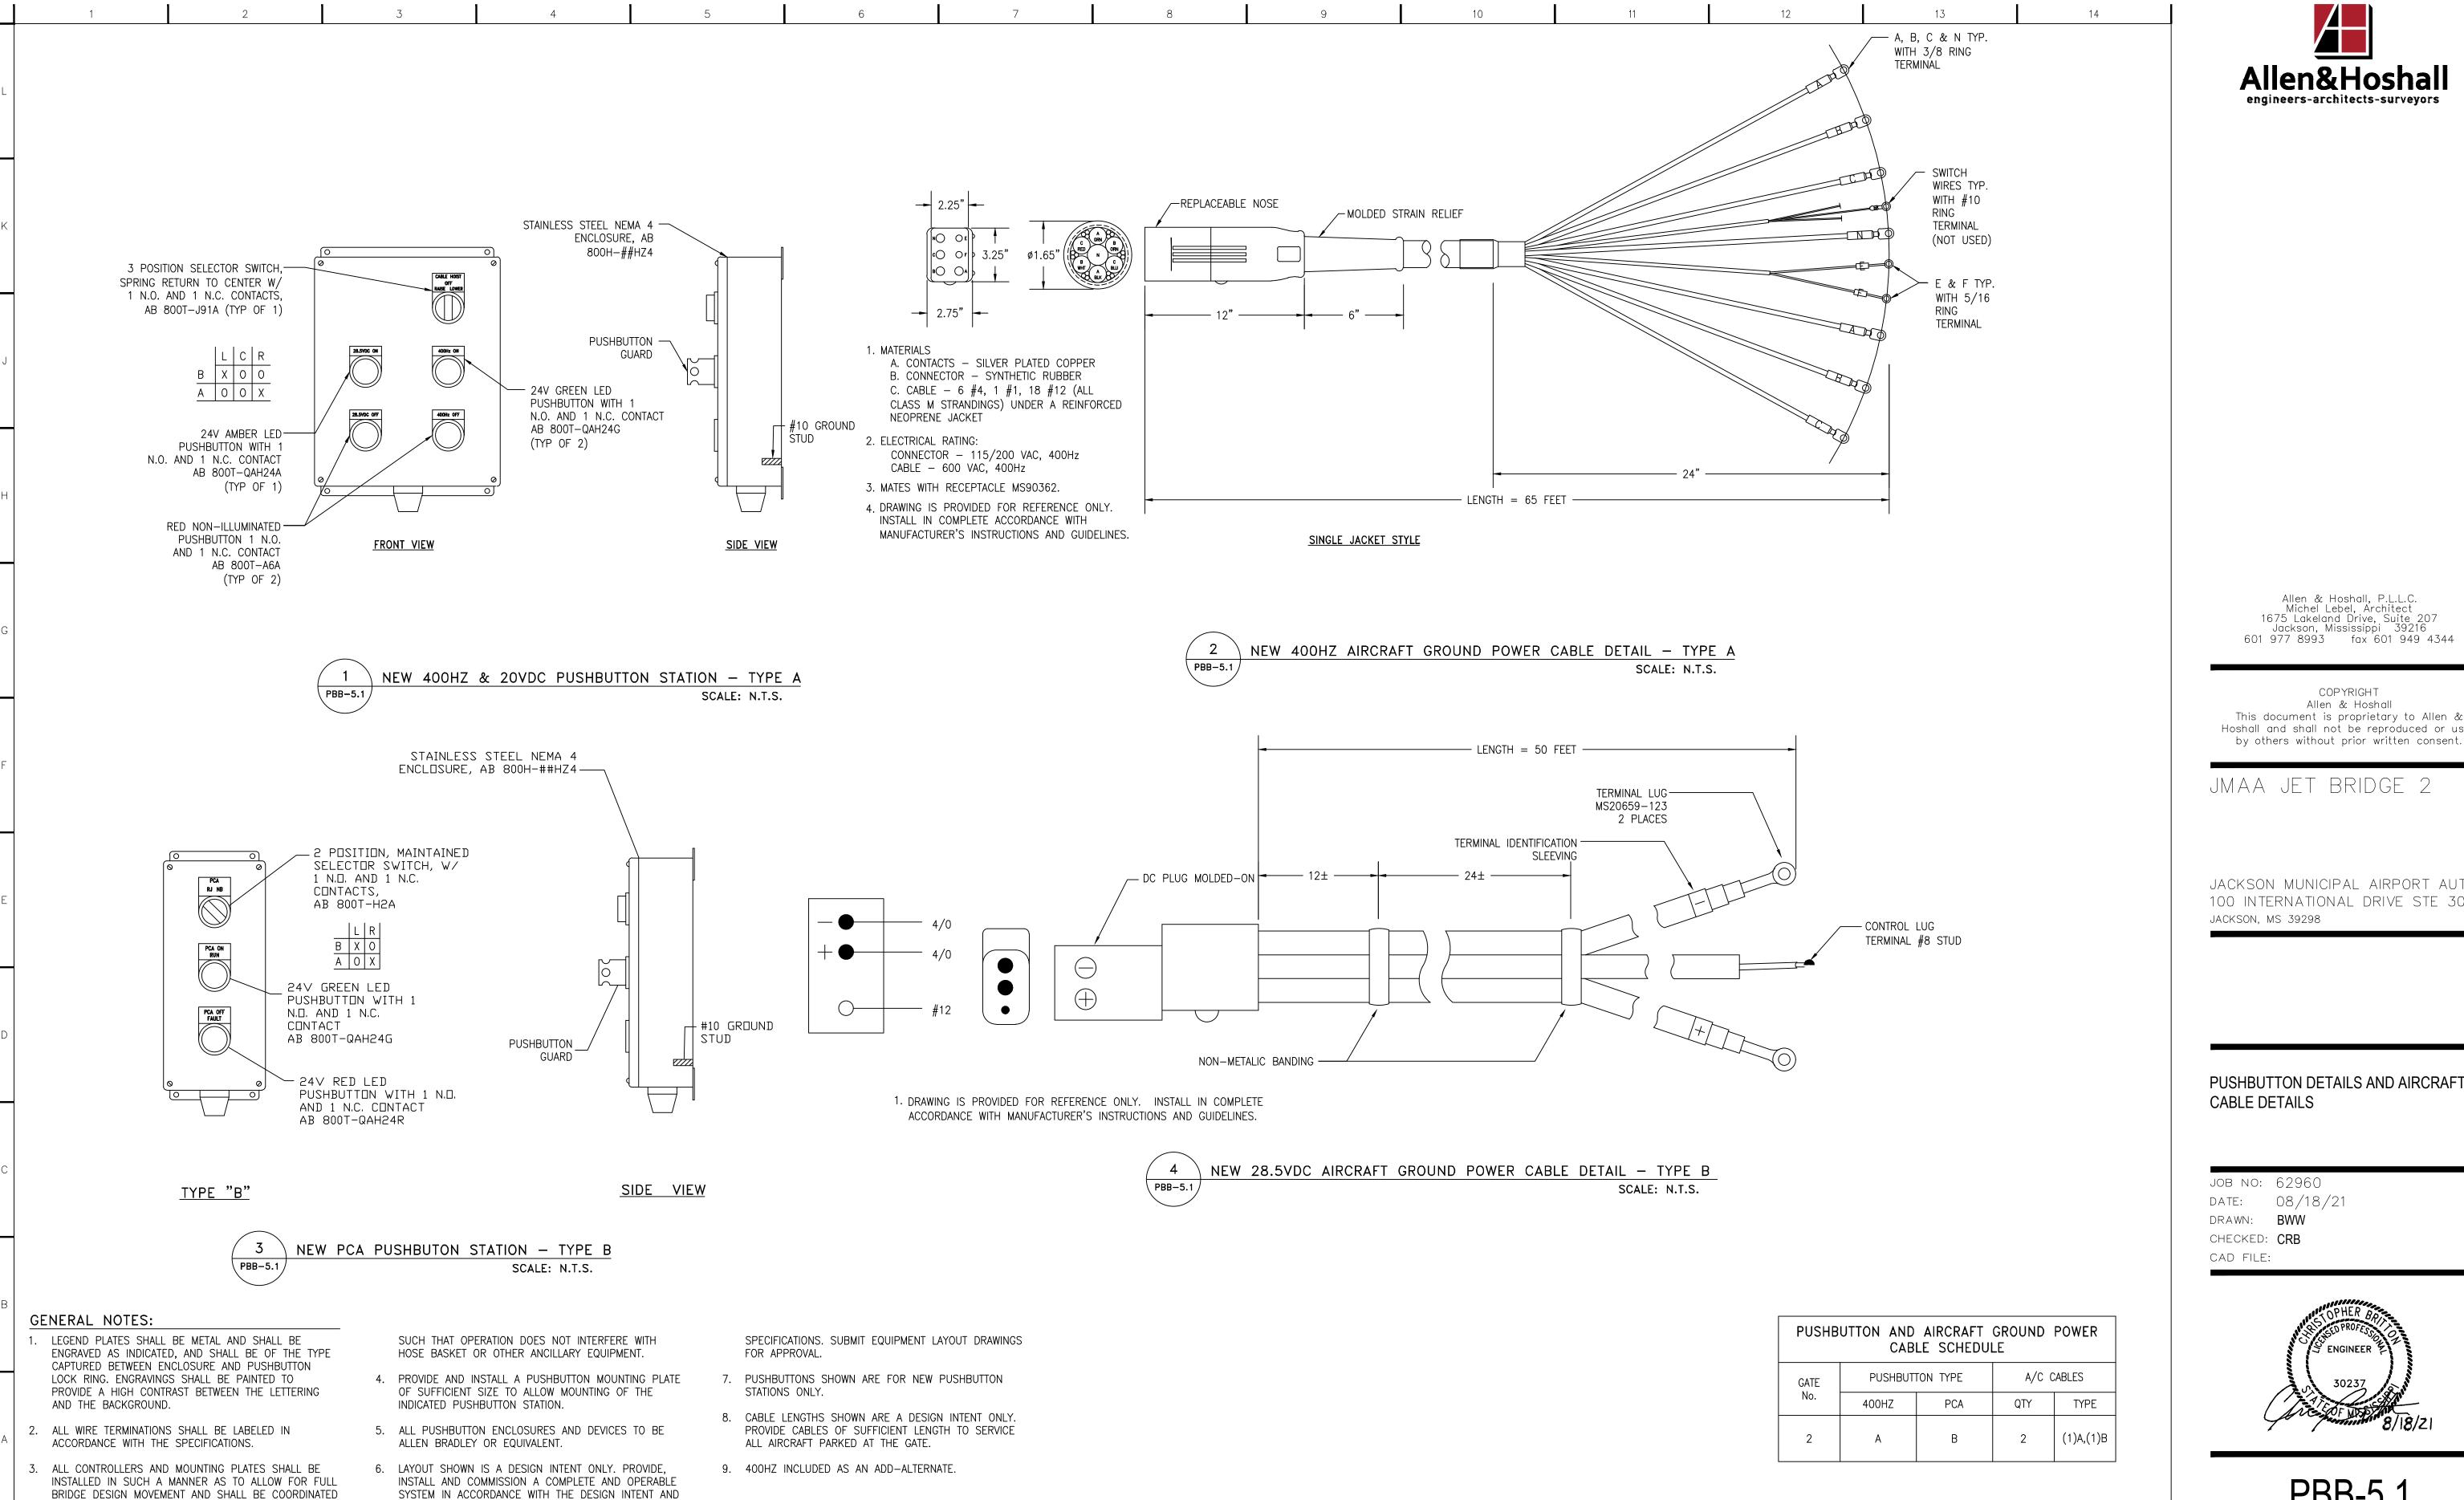



COPYRIGHT Allen & Hoshall This document is proprietary to Allen & Hoshall and shall not be reproduced or used

JMAA JET BRIDGE 2

JACKSON MUNICIPAL AIRPORT AUTHORITY 100 INTERNATIONAL DRIVE STE 300 JACKSON, MS 39298


PUSHBUTTON DETAILS AND AIRCRAFT CABLE DETAILS

JOB NO: 62960 DATE: 08/18/21 DRAWN: **BWW** CHECKED: CRB

CAD FILE:



PBB-5.1

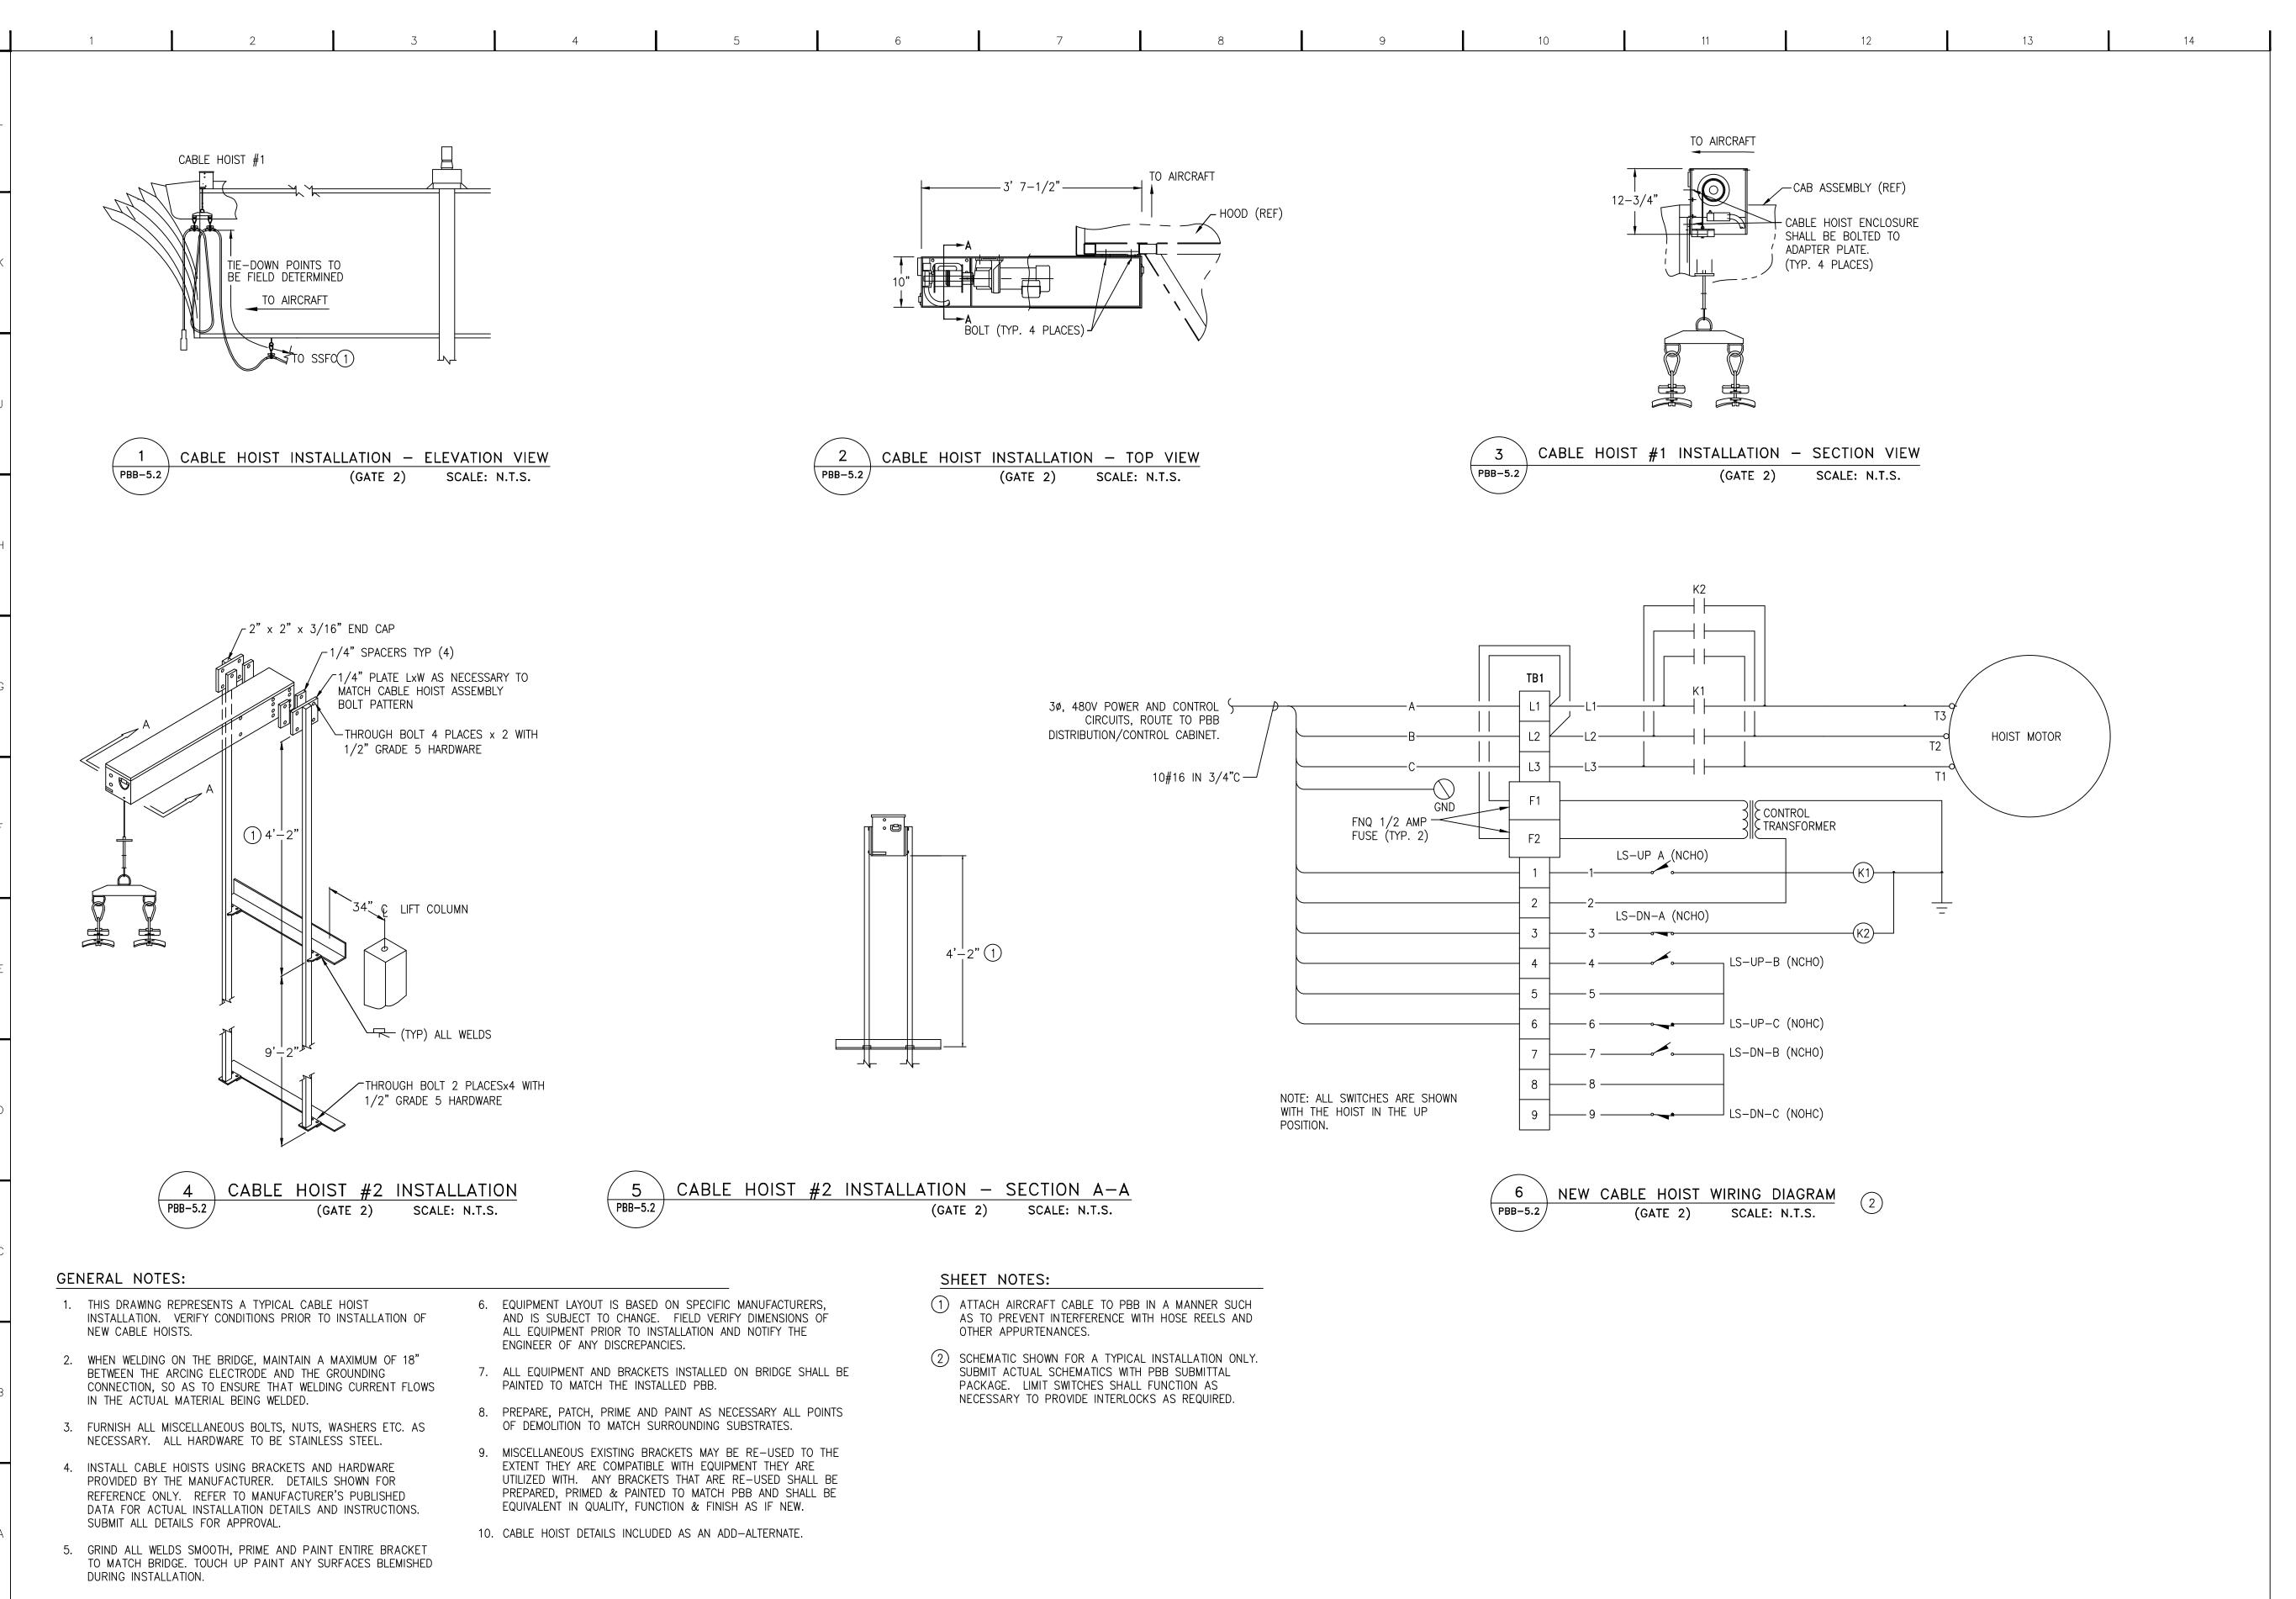

Allen&Hoshal engineers-architects-surveyors

Allen & Hoshall, P.L.L.C. Michel Lebel, Architect 1675 Lakeland Drive, Suite 207 Jackson, Mississippi 39216 601 977 8993 fax 601 949 4344

COPYRIGHT
Allen & Hoshall
This document is proprietary to Allen &
Hoshall and shall not be reproduced or used
by others without prior written consent.

JMAA JET BRIDGE 2

JACKSON MUNICIPAL AIRPORT AUTHORITY 100 INTERNATIONAL DRIVE STE 300 JACKSON, MS 39298

CABLE HOIST DETAILS - GATE 2


JOB NO: 62960

DATE: 08/18/21


DRAWN: BWW

CHECKED: CRB



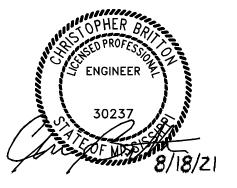

PBB-5.2

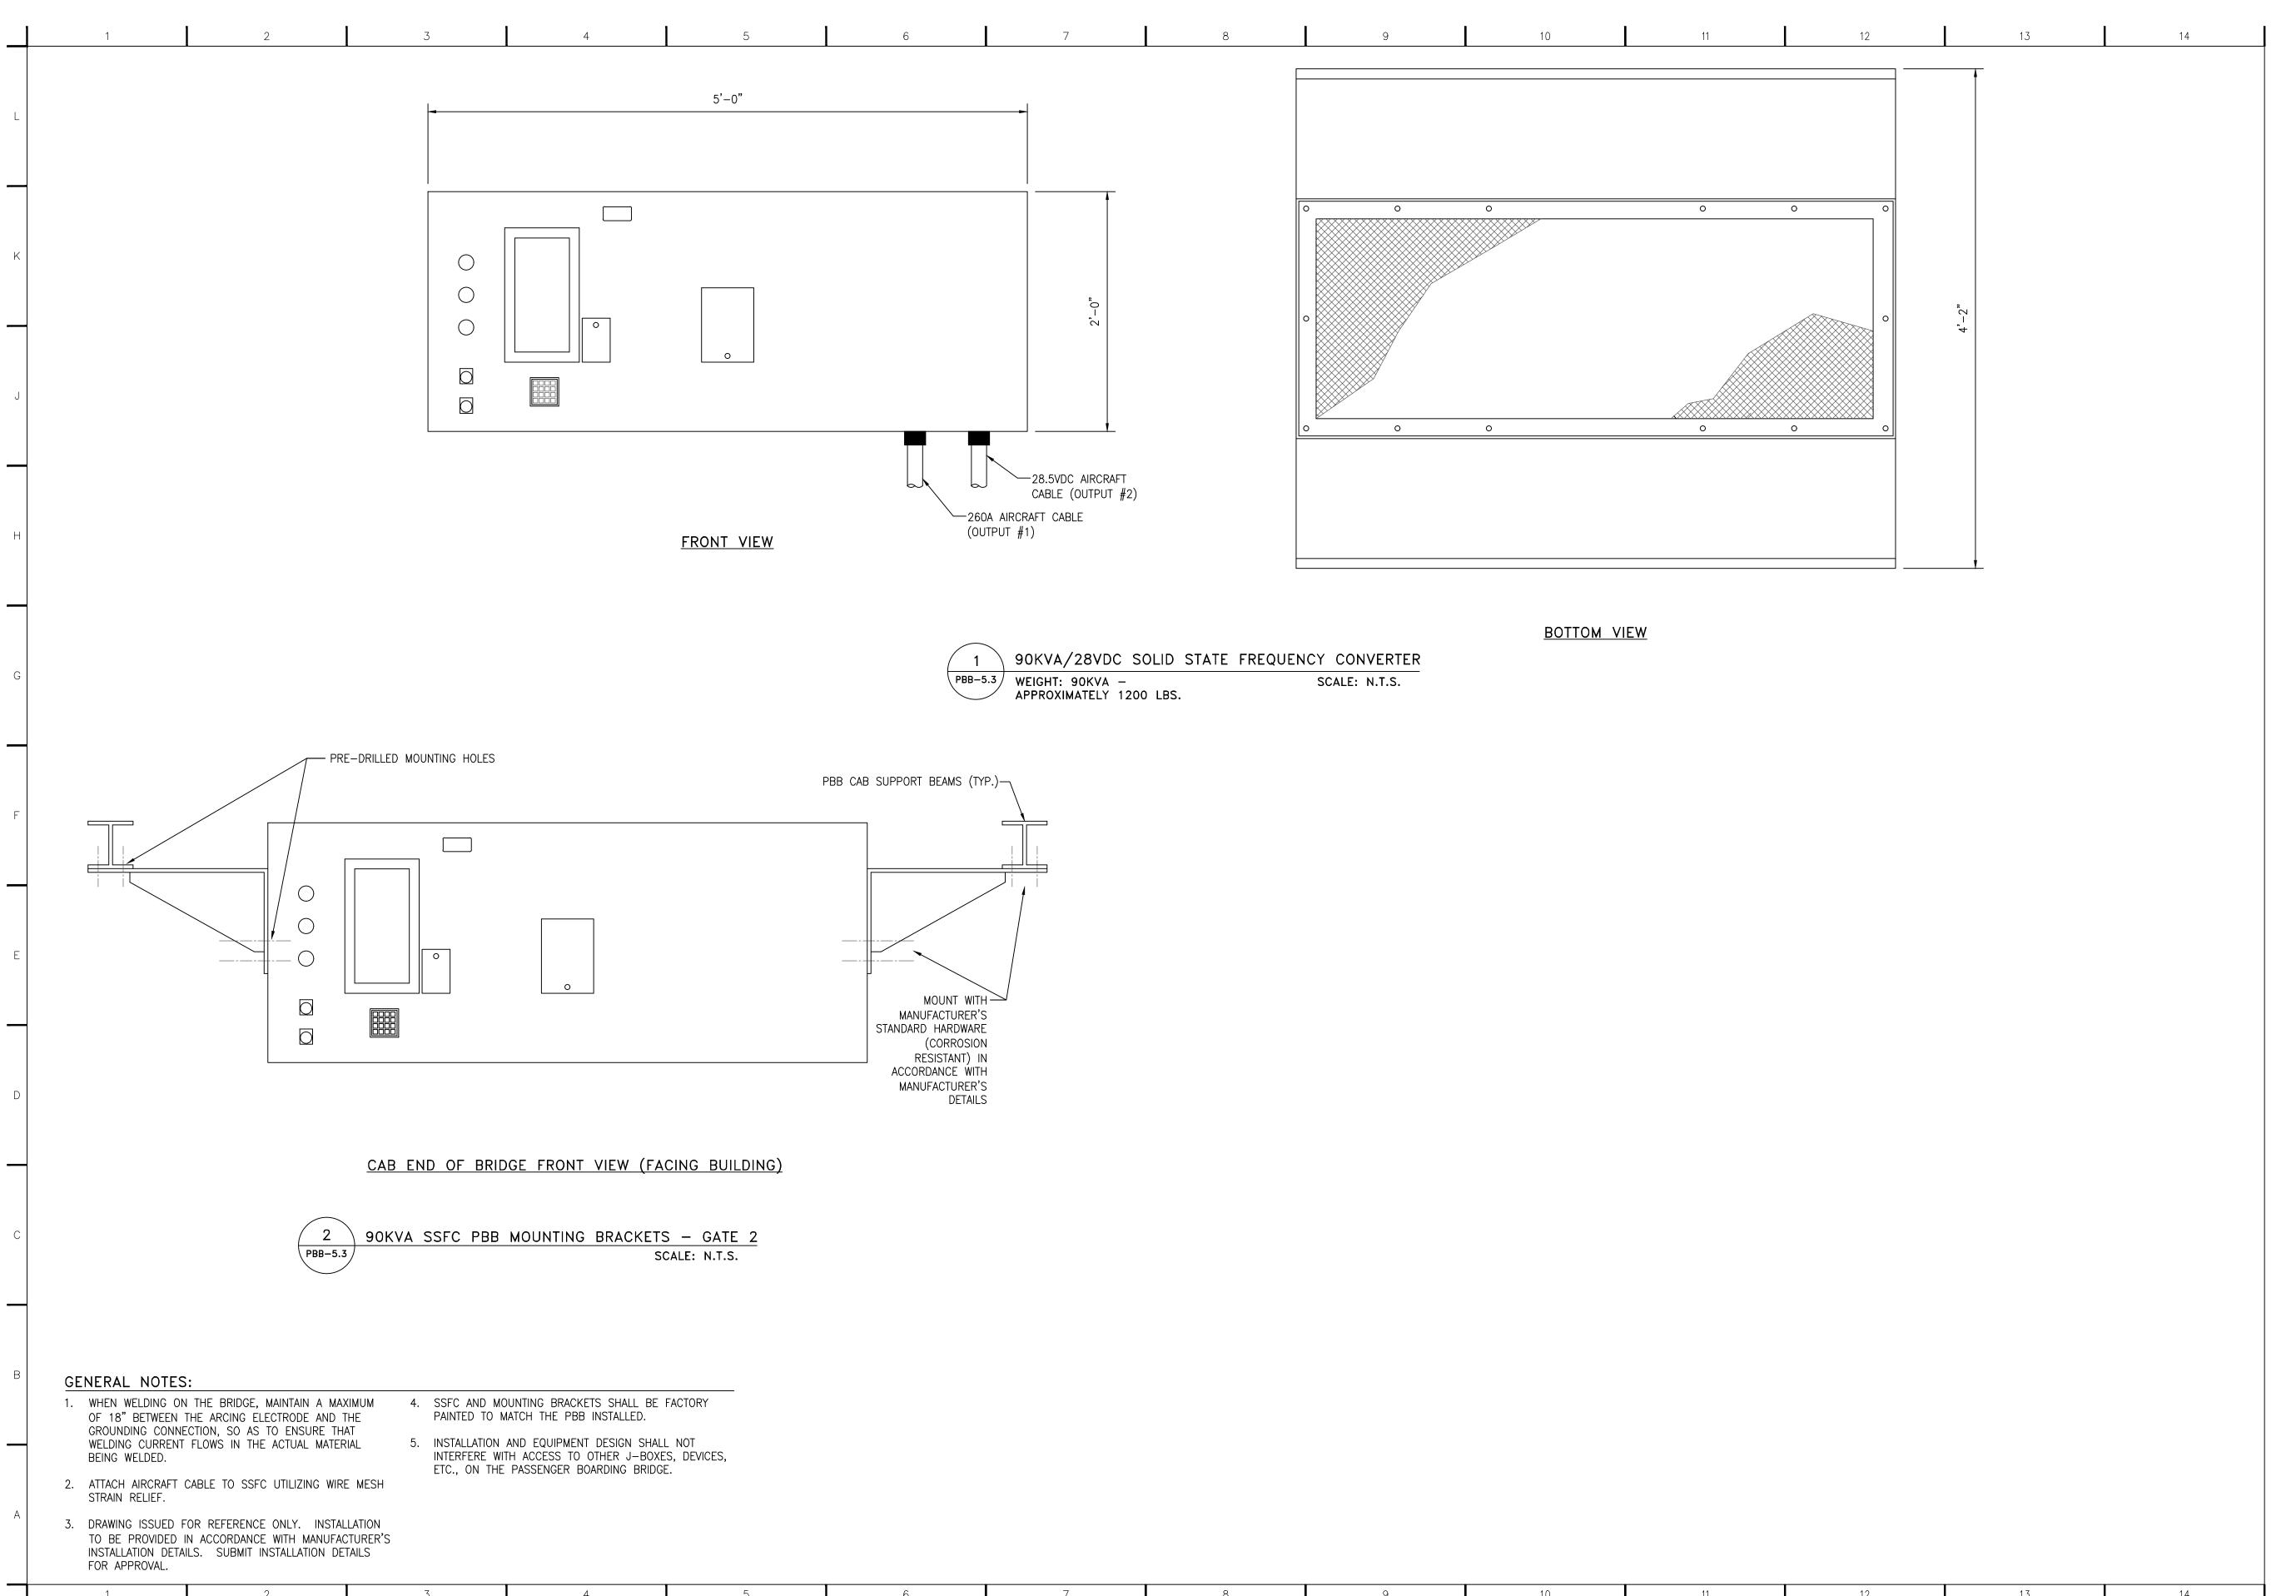



COPYRIGHT

Allen & Hoshall

This document is proprietary to Allen &
Hoshall and shall not be reproduced or used
by others without prior written consent.


JMAA JET BRIDGE 2

JACKSON MUNICIPAL AIRPORT AUTHORITY 100 INTERNATIONAL DRIVE STE 300 Jackson, ms 39298

400HZ EQUIPMENT DETAILS

JOB NO: 62960
DATE: 08/18/21
DRAWN: BWW
CHECKED: CRB

CAD FILE:

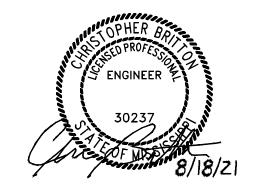

PBB-5.3

GALVANIZED

HORIZONTAL

INT INTERIOR KSI KIPS PER SQUARE INCH LB,# POUNDS LD DEVELOPMENT LENGTH LIVE LOAD LLH LONG LEG HORIZONTAL LLV LONG LEG VERTICAL LONG LONGITUDINAL MANUF **MANUFACTURER** MATL **MATERIAL** MAX MAXIMUM **MECH MECHANICAL** MEZZ MEZZANINE MID MIDDLE MINIMUM MIN MISC MISCELLANEOUS

MTL

N/A

NS

NTS

GALV

**HORIZ** 

O.C. ON CENTER OF OUTSIDE FACE **OPNG** OPENING OPP OPPOSITE PERP PERPENDICULAR PLATE **PRELIN** PRELIMINARY PROJ **PROJECTION** PSF POUNDS PER SQUARE FOOT PSI POUNDS PER SQUARE INCH RAD RADIUS RD ROOF DRAIN REINF REINFORCING (-ED, -MENT) REQ'D REQUIRED REV REVISION SCHED SCHEDULE(D) SECT SECTION SHT SHEET

METAL

NOT APPLICABLE

NEAR SIDE

NOT TO SCALE

SIM SIMILAR SPEC SPECIFICATIONS(S) SQ SOUARE SS STAINLESS STEEL **STRUCT** STRUCTURE SYM SYMMETRICAL TOP, TENSION T/,T.O. TOP OF T/CONC TOP OF CONCRETE T/FTG TOP OF FOOTING T/SLAB TOP OF SLAB T&B TOP & BOTTOM **TEMP TEMPERATURE** THK THICKNESS TOS TOP OF STEEL TOW TOP OF WALL **TRNV** TRANSVERSE TYP TYPICAL UNO UNLESS NOTED OTHERWISE **VERT** VERTICAL

WITH

WITHOUT WORK POINT

W/O

### A. DESIGN CRITERIA

- 1. 2015 INTERNATIONAL BUILDING CODE (IBC)
- 2. LIVE LOADS( REDUCED AS ALLOWED BY BUILDING CODE): 20 PSF (REDUCED BY SLOPE OR AREA) A. ROOF LIVE:

21 PSF

- 3. DEAD LOADS: A. ROOF:
- 4. SNOW LOADS: A. GROUND SNOW LOAD: 10 PSF
- (REF THYSSEN KRIPP AIRPORT SYSTEMS CUTSHEET DATED 07/02/20) A. ULTIMATE WIND SPEED (3 SECOND GUST): 115 MPH
- B. WIND IMPORTANCE FACTOR: C. WIND EXPOSURE: D. INTERNAL PRESSURE COEFFICIENT: ± 0.18
- 6. SEISMIC LOADS (N32.31086°, W90.07411°)
- (REF THYSSEN KRUPP AIRPORT SYSTEMS CUTSHEET DATED 07/02/20) A. RISK CATEGORY:
- B. MAPPED SPECTRAL RESPONSE COEFFICIENTS: S<sub>S</sub> = 0.14 C. DESIGN SPECTRAL RESPONSE COEFFICIENTS:
- D. SOIL SITE CLASS: E. SEISMIC IMPORTANCE FACTOR:  $l_e = 1.00$
- F. SEISMIC RESPONSE COEFFICIENT:  $C_s = 0.06$ EQUIVALENT LATERAL FORCE G. ANALYSIS PROCEDURE:

# **B. GENERAL NOTES**

- 1. NO PROVISION OF ANY REFERENCED STANDARD SPECIFICATION, MANUAL OR CODE (WHETHER OR NOT SPECIFICALLY INCORPORATED BY REFERENCE IN THE CONTRACT DOCUMENTS) SHALL BE EFFECTIVE TO CHANGE THE DUTIES AND RESPONSIBILITIES OF THE OWNER, CONTRACTOR, ARCHITECT, ENGINEER, SUPPLIER, OR ANY OF THE CONSULTANTS, AGENTS, OR EMPLOYEES FROM THOSE SET FORTH IN THE CONTRACT DOCUMENTS, NOR SHALL IT BE EFFECTIVE TO ASSIGN TO THE STRUCTURAL ENGINEER OF RECORD (S.E.R.) OR ANY OF THE S.E.R.'S CONSULTANTS, AGENTS, OR EMPLOYEES ANY DUTY OR AUTHORITY TO SUPERVISE OR DIRECT THE FURNISHING OR PERFORMANCE OF THE WORK OR ANY DUTY OR AUTHORITY TO UNDERTAKE RESPONSIBILITIES CONTRARY TO THE PROVISIONS OF THE CONTRACT DOCUMENTS.
- 2. REFERENCE TO STANDARD SPECIFICATIONS (CONCERNING STRUCTURAL DESIGN) OF ANY TECHNICAL SOCIETY, ORGANIZATION, OR ASSOCIATION OR TO CODES OF LOCAL OR STATE AUTHORITIES, SHALL MEAN THE LATEST STANDARD CODES, SPECIFICATION OR TENTATIVE SPECIFICATION ADOPTED AT THE DATE OF TAKING BIDS, UNLESS SPECIFICALLY STATED OTHERWISE.
- 3. NOTES AND SPECIFIC DETAILS ON THE DRAWINGS SHALL TAKE PRECEDENCE OVER GENERAL STRUCTURAL NOTES AND TYPICAL DETAILS. CONTACT THE ARCHITECT / ENGINEER FOR A DETERMINATION OF INTENT BEFORE PROCEEDING WITH RELATED WORK IF THERE IS ANY DISCREPANCY OR QUESTION REGARDING WHICH NOTE TO FOLLOW.
- 4. FOR DIMENSIONS NOT SHOWN ON THE STRUCTURAL DRAWINGS, SEE THE ARCHITECTURAL
- 5. MATERIAL, WORKMANSHIP, AND DESIGN SHALL CONFORM TO THE REFERENCED BUILDING
- 6. SHOP DRAWING APPROVAL IS ONLY FOR GENERAL CONFORMANCE WITH THE DESIGN CONCEPT OF THE PROJECT AND THE INFORMATION GIVEN IN THE CONTRACT DOCUMENTS. CONTRACTOR SHALL BE RESPONSIBLE FOR DIMENSIONS TO BE CONFIRMED AND CORRELATED AT THE JOB SITE; INFORMATION THAT PERTAINS SOLEY TO THE FABRICATION PROCESS OR TO THE MEANS AND METHODS OF CONSTRUCTION; COORDINATION OF THE WORK OF ALL TRADES; AND PERFORMING ALL WORK IN A SAFE SATISFACTORY MANNER. SHOP DRAWING APPROVAL DOES NOT MODIFY THE CONTRACTOR'S DUTY TO COMPLY WITH THE CONTRACT DOCUMENTS.
- 7. SUBMITTAL REVIEWS BY ALLEN & HOSHALL ARE ONLY FOR GENERAL CONFORMANCE TO THE CONTRACT DOCUMENTS AND ONLY THAT WHICH REMAINS WITHIN THE AGREED UPON SCOPE OF WORK. THE TECHNICAL DESIGN OF THIRD-PARTY SYSTEMS USED FOR CONSTRUCTION MEANS AND METHODS SHALL BE REVIEWED AND DESIGNED BY A DIRECT REPRESENTATIVE OF THE CONTRACTOR. ALLEN & HOSHALL MAINTAINS NO RESPONSIBILITY FOR THE DESIGN OF MEANS AND METHODS AND SHALL ACKNOWLEDGE SUBMITTALS OR REQUESTS FOR INFORMATION IN KIND AS "FOR INFORMATION ONLY" TO BE VERIFIED BY THE CONTRACTOR OR DIRECT REPRESENTATIVE OPERATING SAID MEANS AND METHODS.
- 8. CONTRACTOR SHALL MAKE PROVISION FOR REVIEW TIME OF ALL SUBMITTALS SUBMITTED TO ALLEN & HOSHALL OF NO LESS THAN 10 WORKING DAYS (14 CALENDAR DAYS) FROM THE DATE OF DELIVERY TO ALLEN & HOSHALL.
- 9. SUBMITTALS SHALL BE REPRESENTATIVE OF THE CONTRACTOR'S INTERPRETATION OF THE CONTRACT DOCUMENTS TO ENSURE UNDERSTANDING OF THE PROJECT REQUIREMENTS. ANY SUBMITTALS WITH INFORMATION INDICATING TRANSFERENCE, COPYING, OR ANY OTHER FORM OF DUPLICATION OF DETAILS PRESENTED ON THE CONTRACT DOCUMENTS AS THEIR OWN SHALL BE RETURNED FOR REVISION.

### C. CONTRACT DOCUMENTS

- 1. CONTRACT DOCUMENTS INCLUDE, BUT ARE NOT LIMITED TO, THE STRUCTURAL DOCUMENTS (DRAWINGS AND SPECIFICATIONS), BUT DO NOT INCLUDE SHOP DRAWINGS, VENDOR DRAWINGS, OR MATERIAL PREPARED AND SUBMITTED BY THE CONTRACTOR.
- 2. IN THE EVENT CONTRACT DOCUMENTS CONFLICT WITH THE CODE OF PRACTICE OR SPECIFICATIONS OF ACI, PCI, AISC, AISI, SJI OR OTHER STANDARDS, CONTACT STRUCTURAL ENGINEER FOR CLARIFICATION.
- 3. THE CONTRACTOR SHALL COORDINATE THE ARCHITECTURAL, MECHANICAL, ELECTRICAL, PLUMBING AND CIVIL WORKS WITH THE STRUCTURAL CONTRACT DOCUMENTS. THE ARCHITECT/ENGINEER SHALL BE IMMEDIATELY NOTIFIED OF ANY DISCREPANCIES OR OMMISIONS.
- 4. THE CONTRACTOR SHALL IMMEDIATELY NOTIFY, IN WRITING, THE STRUCTURAL ENGINEER OF CONDITIONS ENCOUNTERED IN THE FIELD THAT ARE CONTRADICTORY TO THOSE SHOWN ON THE CONTRACT DOCUMENTS.

### D. CONTRACTOR RESPONSIBILITIES

- 1. CONTRACTOR SHALL COORDINATE THE STRUCTURAL DOCUMENTS WITH THE ARCHITECTURAL, MECHANICAL, ELECTRICAL, PLUMBING AND VENDOR DOCUMENTS ARCHITECT/STRUCTURAL ENGINEER SHALL BE IMMEDIATELY NOTIFIED OF ANY DISCREPANCY OR OMISSION.
- 2. CONTRACTOR SHALL IMMEDIATELY UPON NOTICE TO PROCEED VERIFY THE DIMENSIONS, ELEVATIONS AND SITE CONDITIONS BEFORE STARTING WORK. ARCHITECT/STRUCTURAL ENGINEER SHALL BE IMMEDIATELY NOTIFIED OF ANY DISCREPANCY.
- 3. CONTRACTOR SHALL VERIFY THE STRUCTURALLY SUPPORTED MECHANICAL EQUIPMENT WEIGHTS, OPENING SIZES AND LOCATIONS IDENTIFIED ON THE STRUCTURAL DRAWINGS WITH ARCHITECTURAL, PLUMBING AND MECHANICAL DRAWINGS.
- 4. CONTRACTOR HAS SOLE RESPONSIBILITY FOR MEANS, METHODS, TECHNIQUES, SEQUENCES, AND PROCEDURES OF CONSTRUCTION.
- 5. CONTRACTOR HAS SOLE RESPONSIBILITY FOR THE DESIGN, ADEQUACY, AND SAFETY OF ERECTION BRACING, SHORING, TEMPORARY SUPPORTS, ETC.
- 6. CONTRACTOR HAS SOLE RESPONSIBILITY TO COMPLY WITH ALL OSHA SAFETY REGULATIONS.

# E. FOUNDATIONS

- FOUNDATIONS ARE DESIGNED BASED UPON SOIL BEARING CAPACITIES AS STATED BELOW. FOUNDATION DESIGNS SUBJECT TO CHANGE UPON RECEIPT AND REVIEW OF THE REQUESTED GEOTECHNICAL REPORT
- 2. ALLOWABLE SOIL BEARING PRESSURES USED IN DESIGN: . SPREAD FOOTINGS:

STATED ASSUMED SOIL BEARING CAPACITIES.

- B. CONTINUOUS FOOTINGS: 3. FOOTING EXCAVATIONS SHALL BE OBSERVED AND TESTED BY AN EXPERIENCED GEOTECHNICAL ENGINEER PRIOR TO STEEL OR CONCRETE PLACEMENT IN ORDER TO ASSESS THAT THE FOUNDATION MATERIALS ARE CONSISTENT WITH ABOVE
- 4. IN THE EVENT THAT THE SOILS TEST RESULTS ARE DISAPPROVED, FOOTING EXCAVATIONS SHALL BE UNDERCUT (UNDER THE DIRECTION OF THE SOILS ENGINEER) UNTIL SOILS OF ADEQUATE BEARDING CAPACITY ARE ENCOUNTERED. BACKFILL UNDER FOOTINGS SHALL CONSIST OF CONCRETE F'C = 2500 PSI @ 28 DAYS PLACED UP TO THE PROPOSED BOTTOM OF FOOTING ELEVATION.
- 5. FOOTINGS SHALL BEAR ON UNDISTURBED RESIDUAL SOILS OR COMPACTED FILL, MAXIMUM DENSITY OF 98% ASTM D-698.
- 6. FOOTING ELEVATIONS SHOWN ON THE PLANS ARE FOR ESTIMATING PURPOSES ONLY. ACTUAL FOOTING ELEVATIONS SHALL BE DETERMINED BY THE CONTRACTOR AT THE SITE AND SHALL BE A MINIMUM OF 12" BELOW FINISHED
- 7. ALL WATER SHALL BE REMOVED FROM FOUNDATION EXCAVATIONS PRIOR TO PLACING OF CONCRETE. IF BOTTOMS OF TRENCHES BECOME SOFTENED DUE TO WATER BEFORE FOOTINGS ARE CAST, THE CONTRACTOR, AT HIS OWN EXPENSE, SHALL EXCAVATE THE SOFTENED MATERIAL AND REPLACE WITH CONCRETE.
- 8. ALL PIPES (WATER LINES, SEWER LINES, ETC.) AND CONDUITS RUNNING THROUGH WALLS / SLABS SHALL BE PROTECTED WITH 1/2" EXPANSION MATERIAL.
- 9. REFER TO CIVIL PLANS FOR LIMITS OF EXCAVATION.

### F. CONCRETE

- 1. ALL PHASES OF WORK PERTAINING TO THE CONCRETE CONSTRUCTION SHALL CONFORM EDITION WITH MODIFICATIONS AS NOTED IN THE DRAWINGS OR SPECIFICATIONS.
- 2. CONCRETE MIXES SHALL BE DESIGNED BY A QUALIFIED TESTING LABORATORY AND
- 3. ALL EXPOSED CORNERS OR EDGES OF COLUMNS, PIERS, WALLS, ETC., SHALL BE FORMED
- 4. ALL REINFORCING BARS, ANCHOR BOLTS AND OTHER CONCRETE INSERTS SHALL BE WELL
- 5. PROVIDE SLEEVES FOR PLUMBING AND ELECTRICAL OPENINGS IN CONCRETE BEFORE PLACING CONCRETE. DO NOT CUT ANY REINFORCING THAT MAY CONFLICT. CORING IS NOT PERMITTED EXCEPT AS SHOWN. NOTIFY THE STRUCTURAL ENGINEER IN ADVANCE OF CONDITIONS NOT SHOWN ON THE DRAWINGS.
- 6. CONDUIT OR PIPE SIZE (O.D.) SHALL NOT EXCEED 30% OF THE SLAB THICKNESS AND SHALL BE PLACED BETWEEN THE TOP AND BOTTOM REINFORCING UNLESS SPECIFICALLY DETAILED OTHERWISE. CONCENTRATIONS OF CONDUITS OR PIPES SHALL BE AVOIDED
- 7. CURING COMPOUNDS ON CONCRETE THAT IS TO RECEIVE SPECIAL FINISH SHALL BE APPROVED BY THE MANUFACTURER BEFORE USE.
- 8. ROUGHEN SURFACE OF HORIZONTAL OR NEARLY HORIZONTAL CONSTRUCTION JOINTS SO THAT THE AGGREGATE SHALL BE EXPOSED UNIFORMLY, LEAVING NO LAITANCE, LOOSED PARTICLES OR DAMAGED CONCRETE.
- 9. LOCATE JOINTS NOT INDICATED TO LEAST IMPAIR STRENGTH AND APPEARANCE OF THE STRUCTURE. LOCATE HORIZONTAL JOINTS IN CONCRETE ONLY WHERE THEY NORMALLY OCCUR OR WHERE INDICATED. LOCATE VERTICAL JOINTS IN MIDDLE THIRD OF SPANS OF SLABS, BEAMS, OR GIRDERS UNLESS A BEAM INTERSECTS A GIRDER AT MIDDLE LOCATION, IN WHICH CASE OFFSET JOINTS IN GIRDERS TWICE THE WIDTH OF THE BEAM.
- 10. ONCE FORMWORK HAS BEEN REMOVED FROM CONCRETE RETAINING WALLS, BRACE WALLS THOROUGHLY BEFORE PLACING SOIL AGAINST WALL AND KEEP BRACING IN PLACE FOR A MINIMUM OF 7 DAYS AFTER EARTHWORK IS COMPLETE.
- 11. "WET SETTING" OF ANCHORS, DOWELS AND EMBEDED ITEMS SHALL BE PROHIBITED UNLESS SPECIFICALLY NOTED ON THE DRAWINGS.
- 12. CONCRETE STRRENGTH AND EXPOSURE REQUIREMENTS:
- A. FOUNDATION CONCRETE: 5000 PSI.
- D. ALL CEMENT SHALL BE PORTLAND CEMENT TYPE 1

## G. REINFORCING

- **DETAILING MANUAL.**
- 2. REINFORCING BARS SHALL CONFORM TO THE REQUIREMENTS OF ASTM A615 GRADE 60 EXCEPT ALL REINFORCING IN CONCRETE MOMENT FRAMES AND SHEA
- 3. WELDED WIRE FABRIC SHALL CONFORM TO ASTM A185.
- WHICHEVER IS GREATER.
- 7. PROVIDE (2) #5 EXTRA REINFORCING BARS AROUND ALL SIDE OF OPENINGS IN
- 8. MINIMUM CLEAR COVERAGE OF CONCRETE OVER REINFORCEMENT SHALL BE:
- B. CONCRETE EXPOSED TO EARTH OR WEATHER:
- b. NO. 5 BAR, W31 OR D31 WIRE OR SMALLER
- a. SLABS WALLS AND JOISTS NO. 14 & NO. 18
- b. SLABS WALLS AND JOISTS NO. 11 & SMALLER
- c. BEAMS, COLUMNS: TIES AND PRIMARY REINFORCING

- TO THE "BUILDING CODE REQUIREMENTS FOR STRUCTURAL CONCRETE" (ACI 318), LATEST
- APPROVED BY THE STRUCTURAL ENGINEER.
- WITH A 3/4" CHAMFER UNLESS NOTED OTHERWISE ON STRUCTURAL OR ARCHITECTURAL DRAWINGS.
- SECURED IN POSITION PRIOR TO PLACING CONCRETE.
- EXCEPT WHERE DETAILED OPENINGS ARE PROVIDED.

- B. ALL EXPOSED EXTERIOR CONCRETE TO HAVE MINIMUM STRENGTH OF 4500 PSI.
- C. ALL AGGREGATE SHALL BE LIMESTONE.

- 1. REINFORCING SHALL BE DETAILED AND PLACED IN CONFORMANCE WITH ACI
- WALLS AND ALL WELDED REINFORCEMENT SHALL CONFORM TO ASTM A706 GRADE
- 4. MINIMUM LAP OF WELDED WIRE FABRIC SHALL BE 6" OR ONE FULL MESH + 2",
- 5. DOWELS BETWEEN FOOTINGS AND WALLS SHALL BE THE GRADE, SIZE AND SPACING OR NUMBER AS THE VERTICAL REINFORCING, RESPECTIVELY.
- 6. REINFORCING STEEL IN ALL CONCRETE WALLS AND FOOTINGS SHALL BE CONTINUOUS AROUND CORNERS.
- CONCRETE, UNLESS NOTED OTHERWISE ON THE PLANS. EXTEND BARS 2'-0" BEYOND EACH EDGE OF OPENING.
- A. CONCRETE CAST AGAINST AND PERMANENTLY EXPOSED TO EARTH
- a. NO. 6 THROUGH NO. 18 BAR
  - 1-1/2"
- C. CONCRETE NOT EXPOSED TO WEATHER OR IN CONTACT WITH GROUND: 1-1/2"
  - 1-1/2"



Allen & Hoshall, P.L.L.C. Michel Lebel, Architect 1675 Lakeland Drive, Suite 207 Jackson, Mississippi 39216 601 977 8993 fax 601 949 4344

COPYRIGHT Allen & Hoshall This document is proprietary to Allen & Hoshall and shall not be reproduced or used by others without prior written consent.

JMAA JET BRIDGE 2

JACKSON, MS 39298


JACKSON MUNICIPAL AIRPORT AUTHORITY 100 INTERNATIONAL DRIVE STE 300

STRUCTURAL GENERAL NOTES

JOB NO: 62960 08/18/21 DRAWN: CWS MES CHECKED:

CAD FILE:



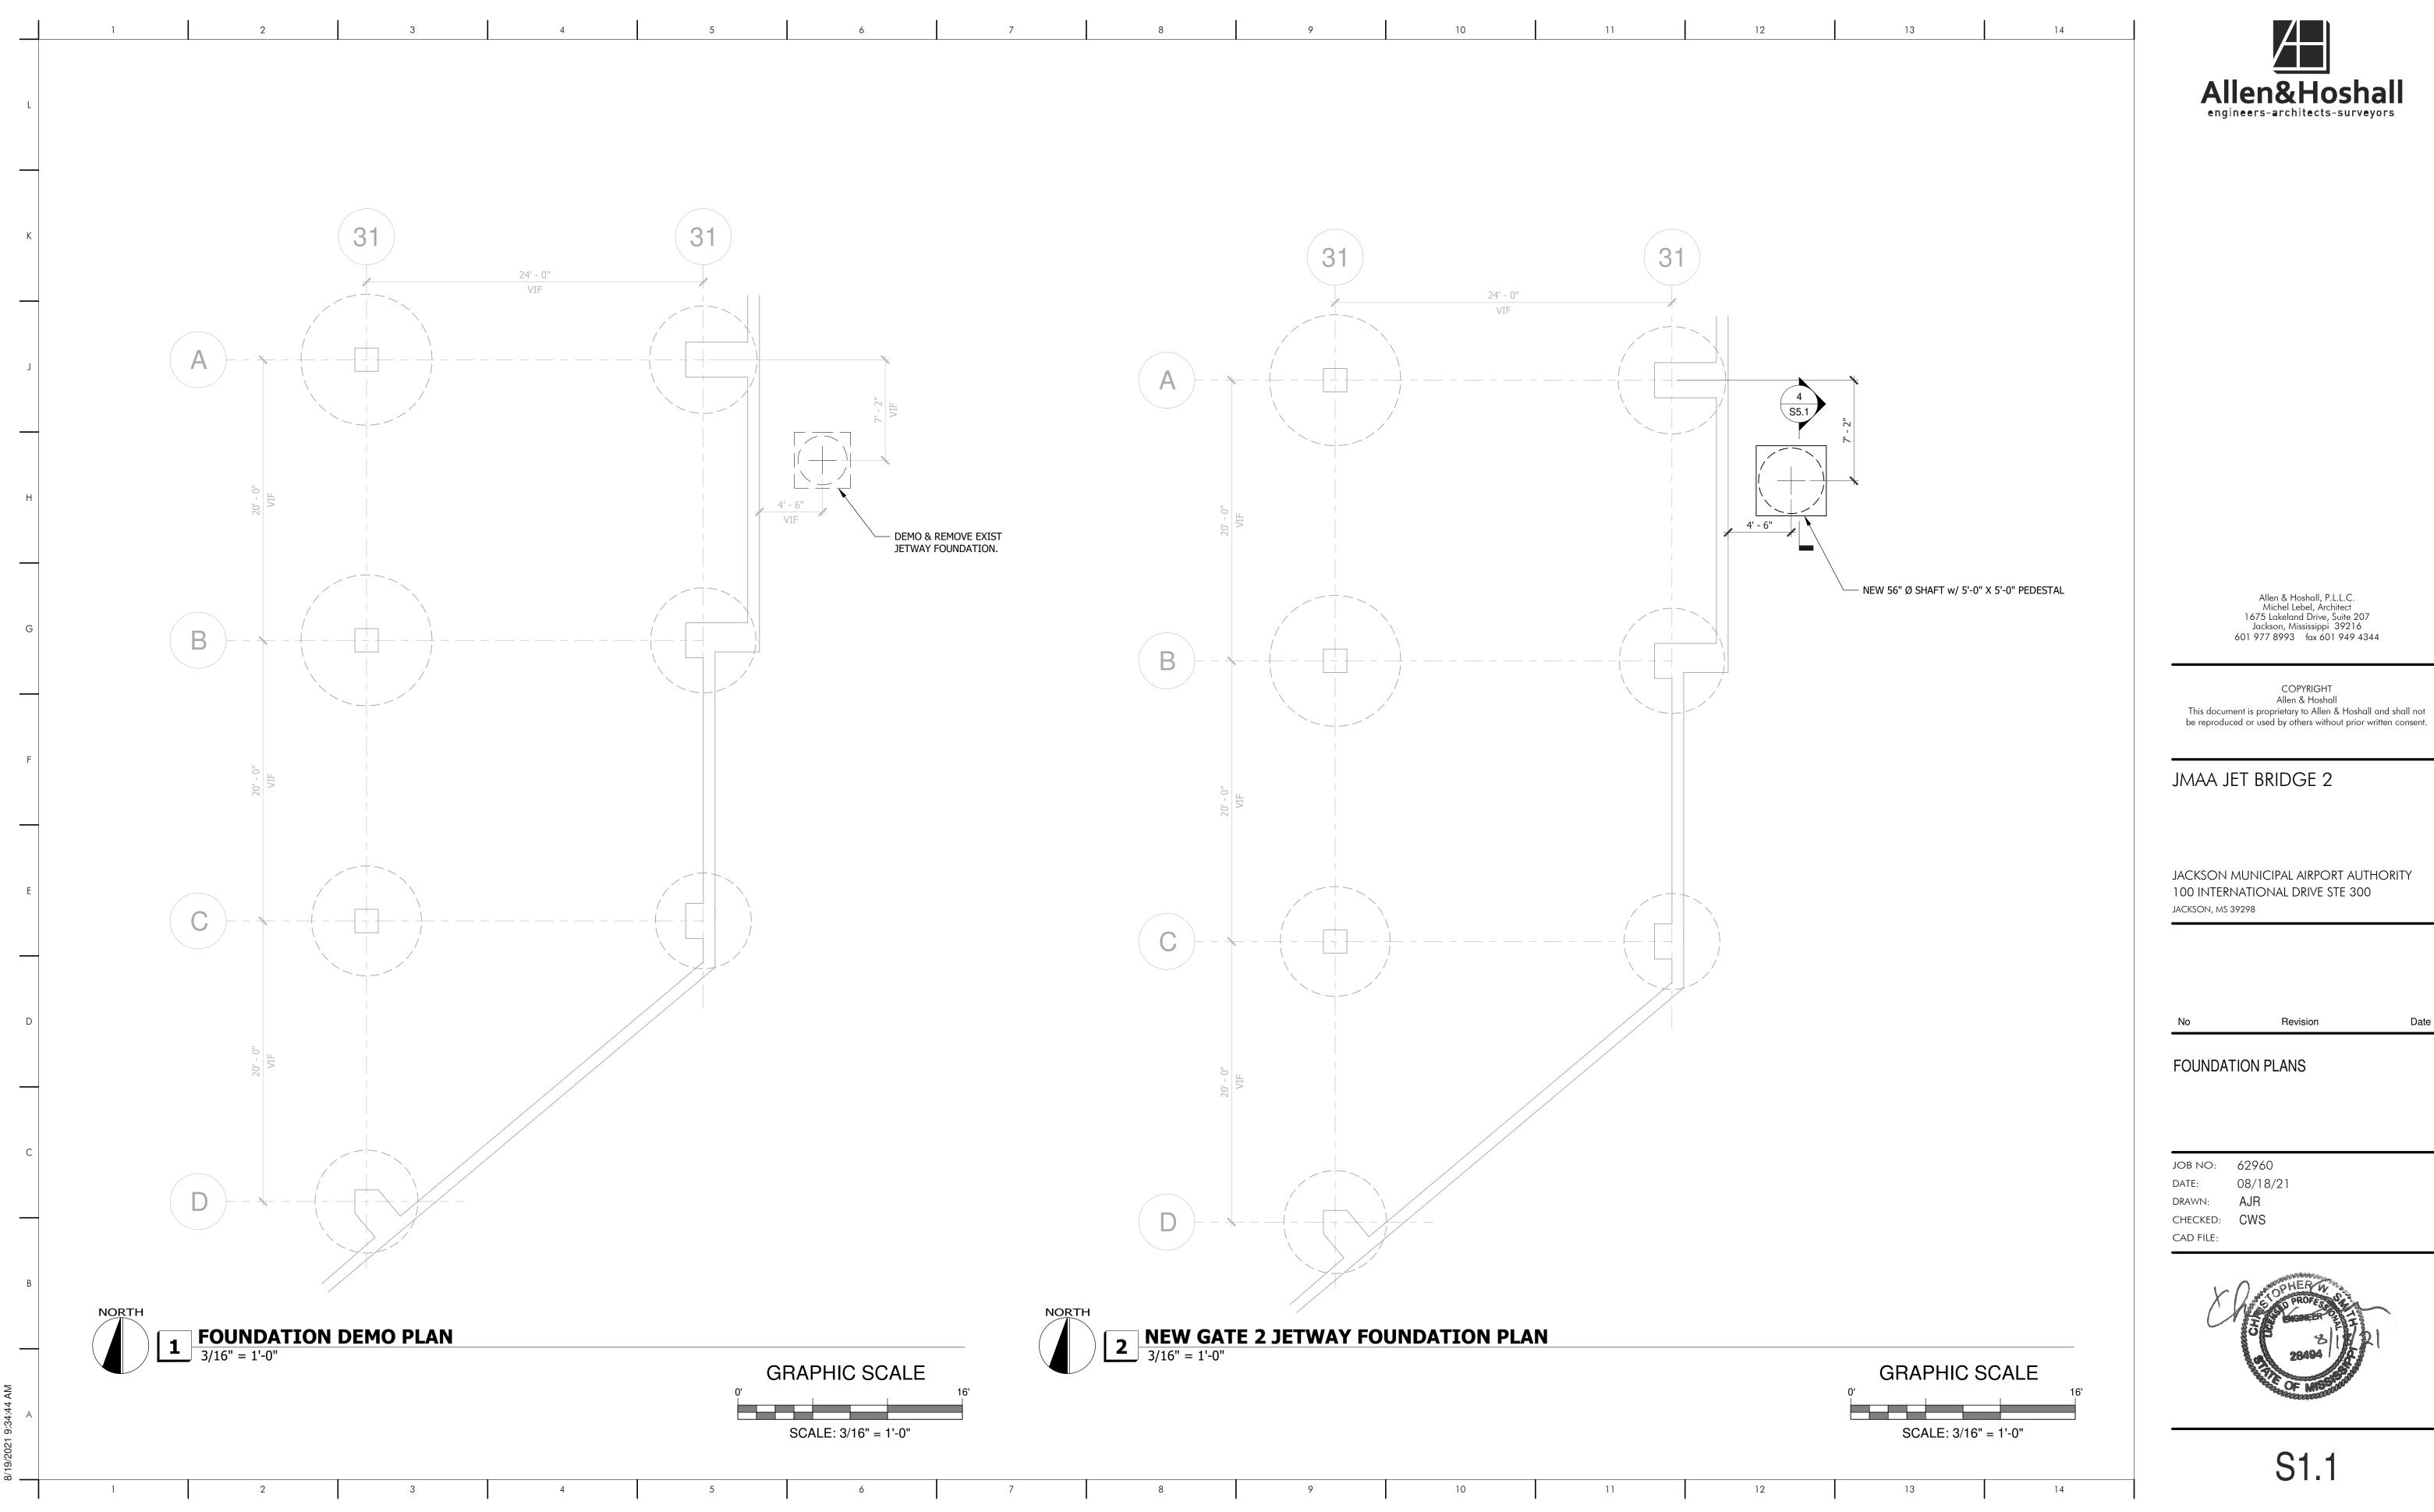




COPYRIGHT Allen & Hoshall This document is proprietary to Allen & Hoshall and shall not

JACKSON MUNICIPAL AIRPORT AUTHORITY 100 International drive Ste 300



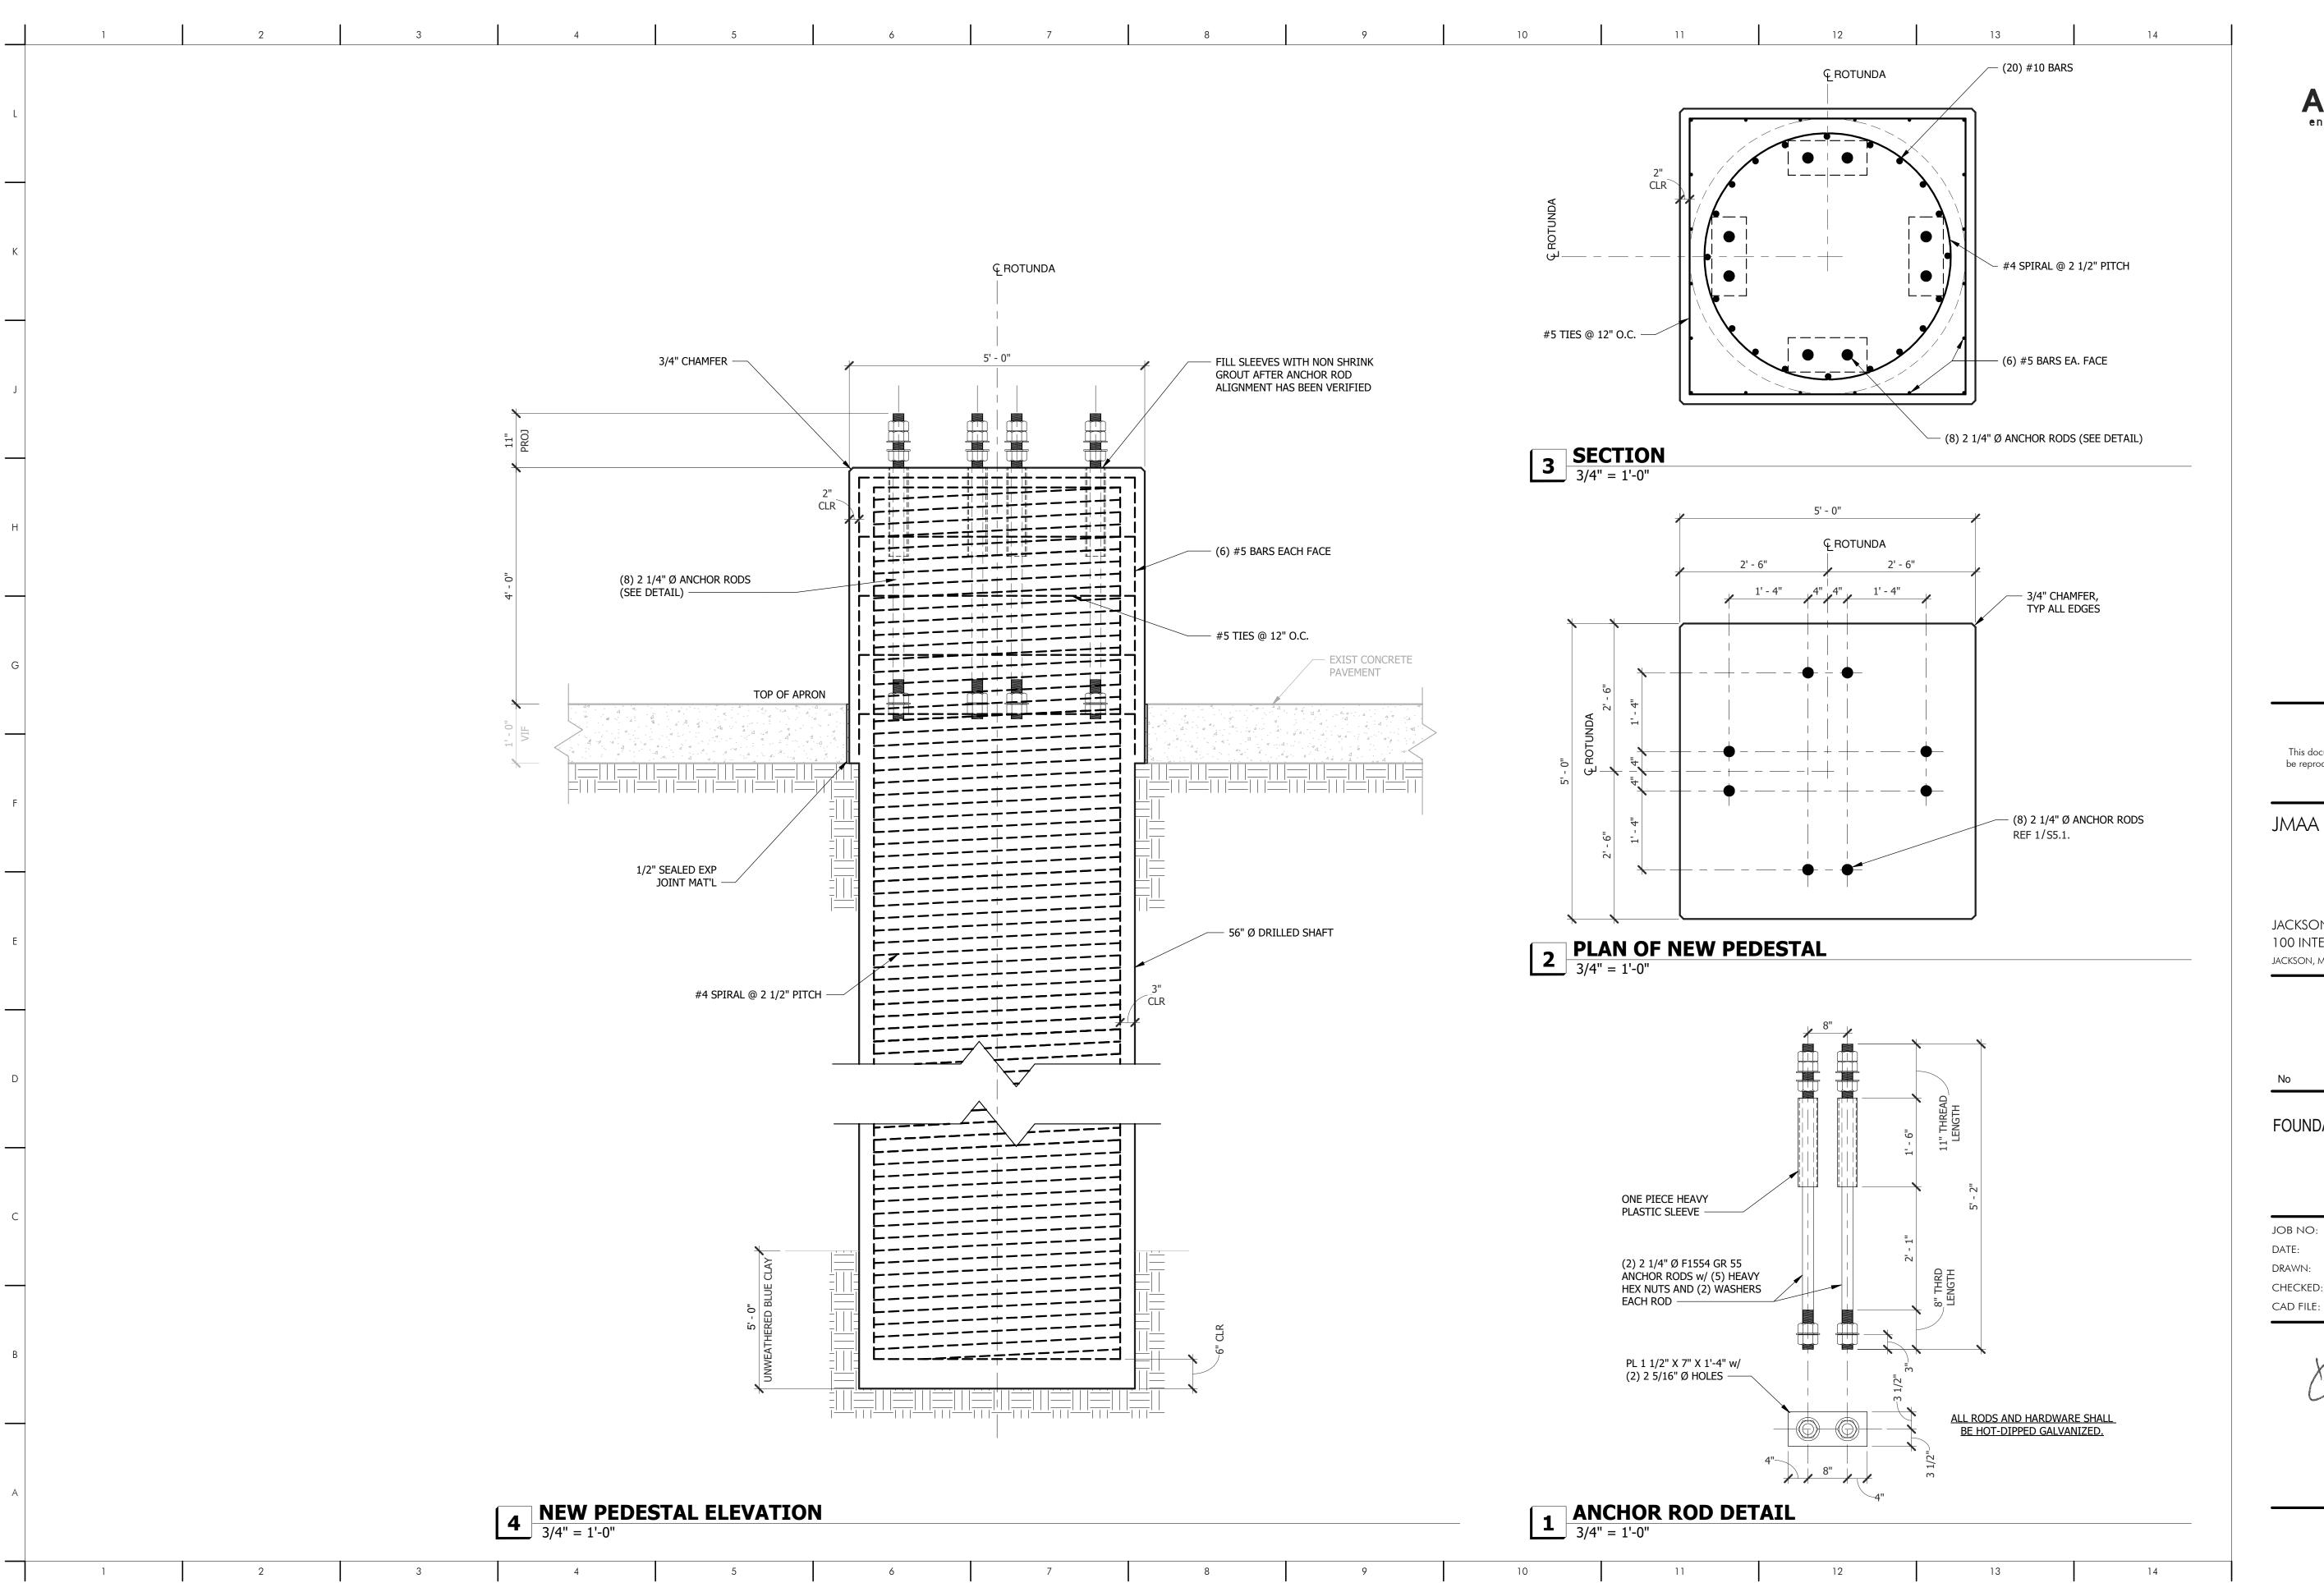



COPYRIGHT
Allen & Hoshall
This document is proprietary to Allen & Hoshall and shall not be reproduced or used by others without prior written consent.

JMAA JET BRIDGE 2

JACKSON MUNICIPAL AIRPORT AUTHORITY 100 INTERNATIONAL DRIVE STE 300 JACKSON, MS 39298

No Revision I


FOUNDATION DETAILS

JOB NO: 62960


DATE: 08/18/21

DRAWN: AJR


CHECKED: CWS

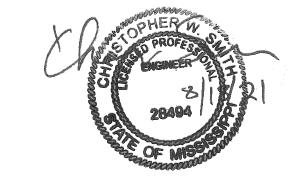

S5.1

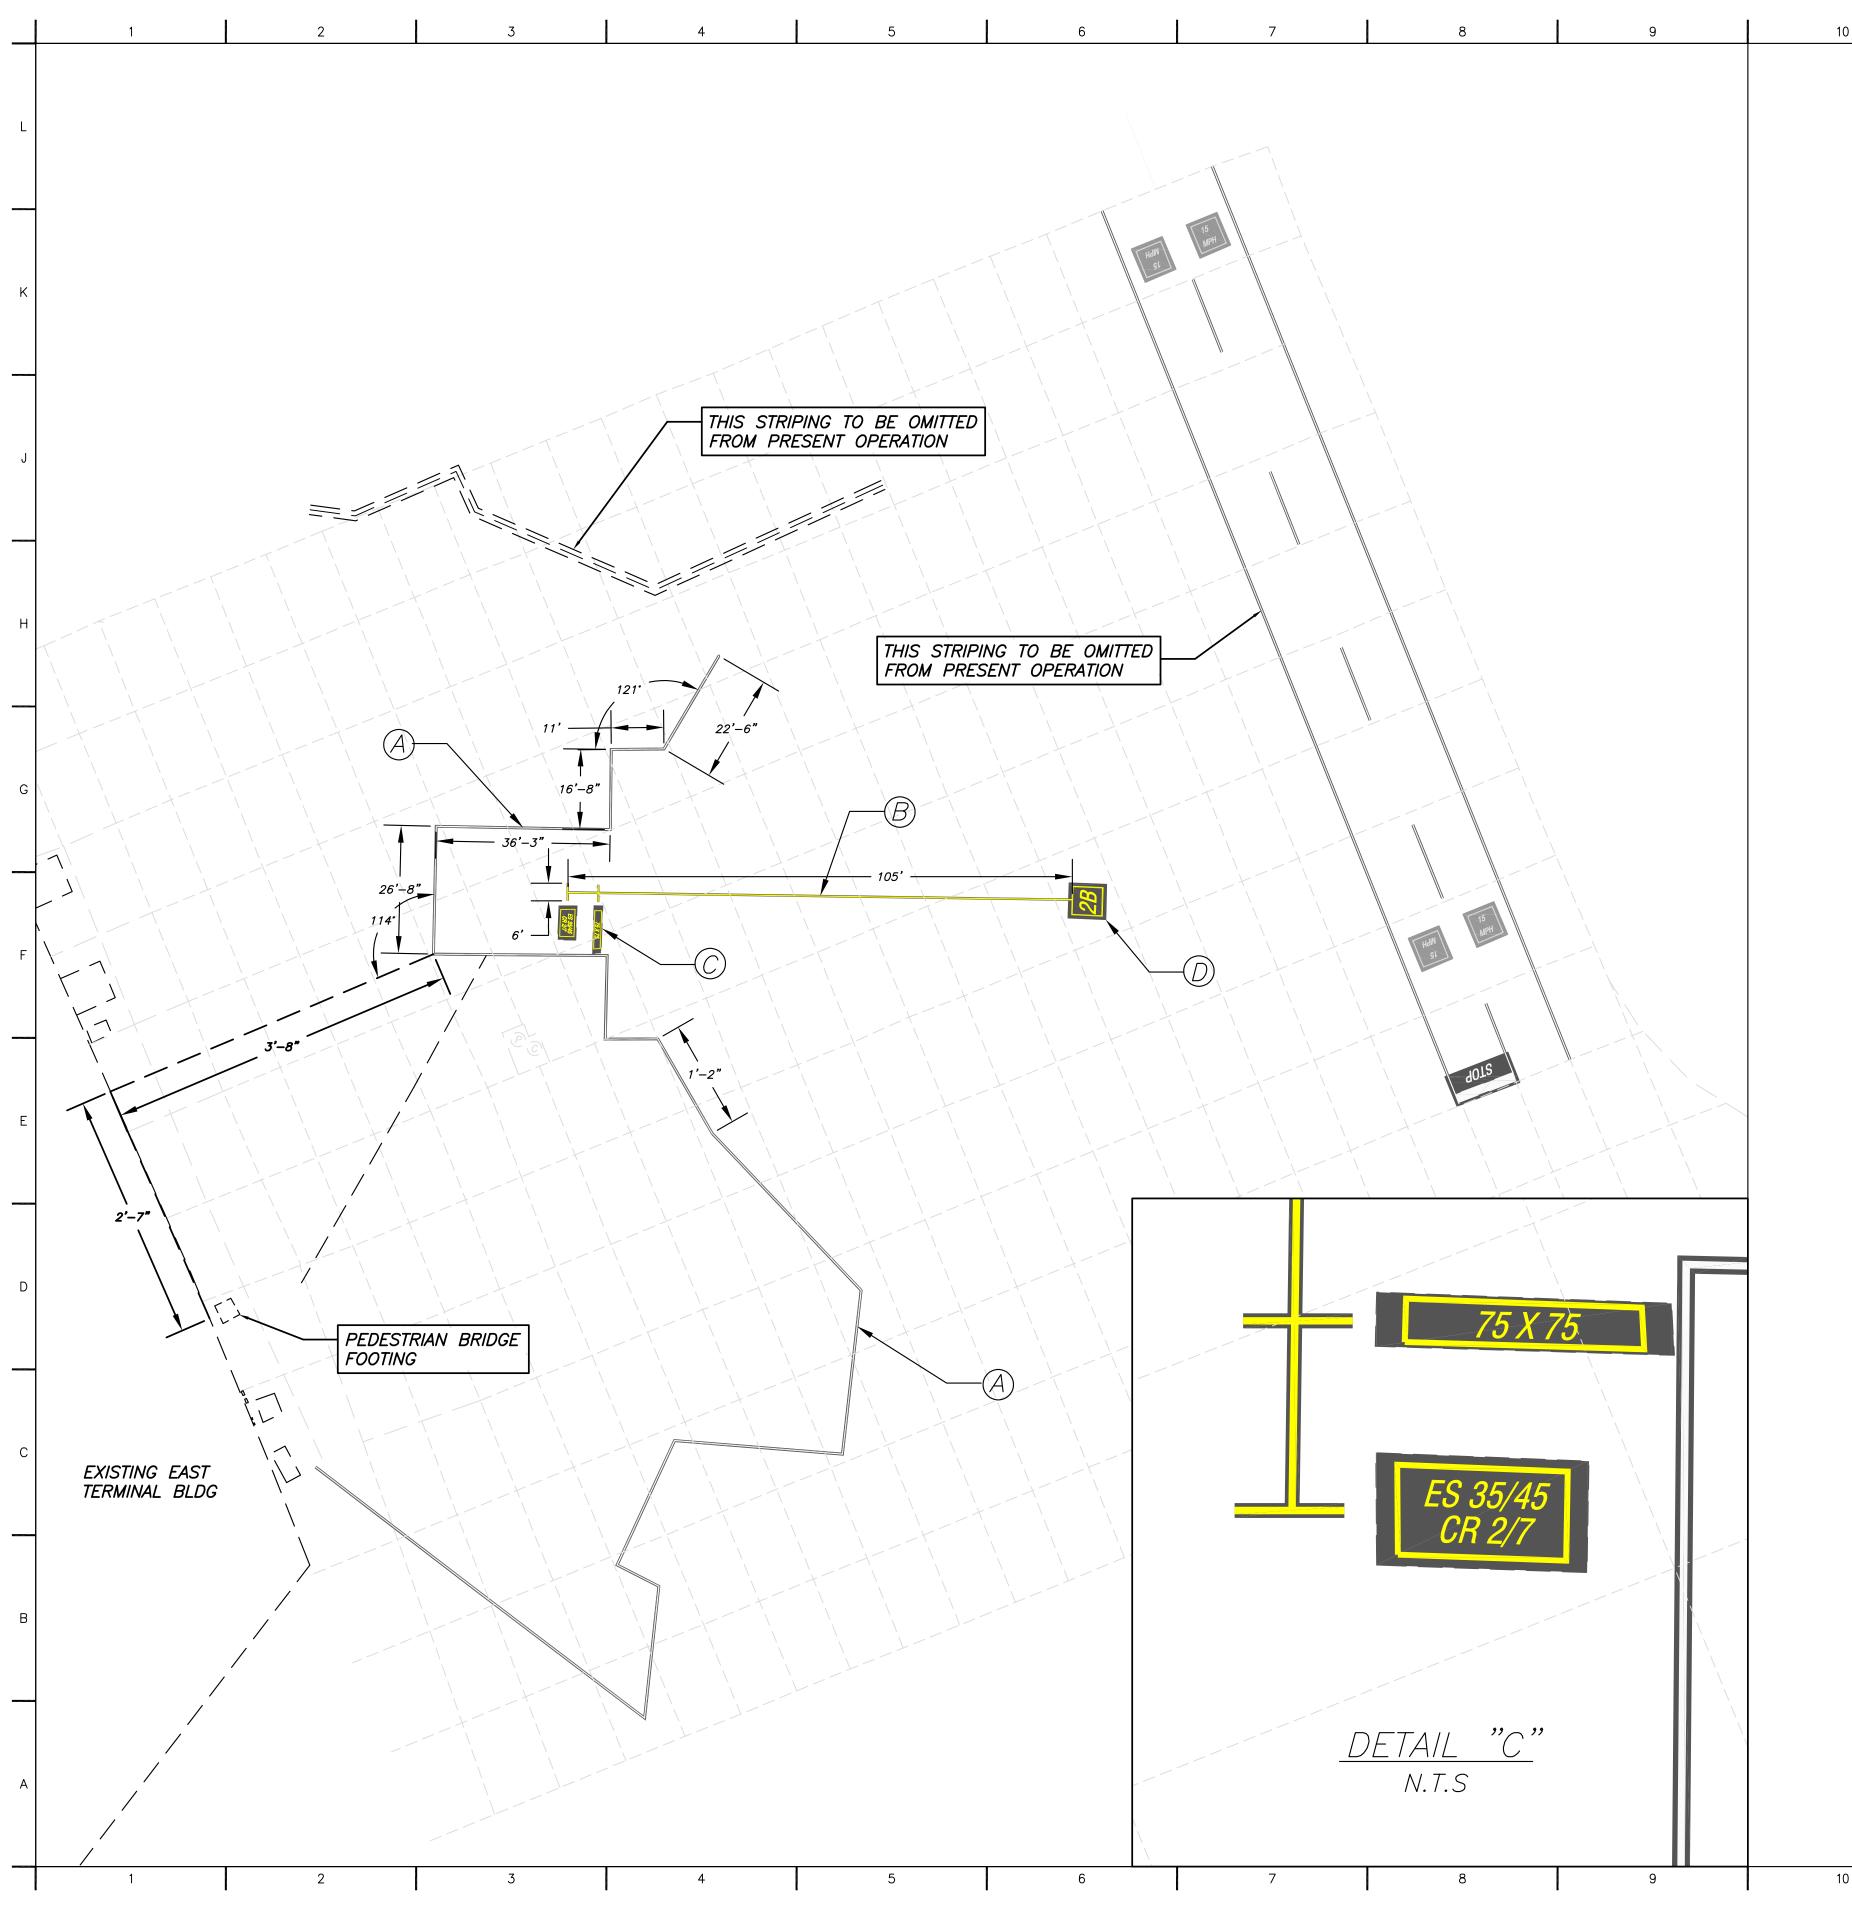





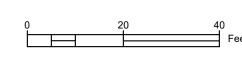

### NOTES;


- 1. PROPOSED PAVEMENT MARKINGS SHALL CORRESPOND TO EXISTING PAVEMENT MARKINGS UNLESS SHOWN OR DESCRIBED OTHERWISE.
- 2. ALL PRIMARY PAVEMENT MARKINGS SHALL HAVE BLACK
  BACKGROUND/BORDER AS REQUIRED FOR CONCRETE SURFACE.
- 3. ALL EXISTING PAVEMENT MARKINGS CORRESPONDING TO THE PROPOSED MARKINGS ARE TO BE REMOVED VIA GRINDING OR SANDBLASTING, WITH THE SURFACE BEING CLEANED OF ALL DEBRIS AND RESIDUE PRIOR TO PLACEMENT OF NEW MARKINGS. NO SEPARATE PAYMENT WILL BE MADE FOR CLEANING AND SURFACE PREPARATION; THE COST FOR THIS WORK IS TO BE ABSORBED INTO OTHER ITEMS BID.
- 4. ALL PAVEMENT MARKINGS SHALL COMPLY WITH THE REQUIREMENTS OF FAA ADVISORY CIRCULAR 150/5340-1M, LATEST PUBLISHING AND/OR ERRATA, FAA ADVISORY CIRCULAR 150/5370-10H, LATEST PUBLISHING AND/OR ERRATA, AND WITH THE REQUIREMENTS OF FAA "QUICK REFERENCE TO AIRFIELD STANDARDS", LATEST PUBLICATION DATE, AS APPLICABLE.
- 5. THE CONTRACTOR SHALL, AT ALL TIMES, MAINTAIN A WORK AREA SURFACE THAT IS CLEAN AND CLEAR OF DEBRIS WHICH MAY BECOME FOD OR OTHER IMPEDIMENT TO AIRCRAFT OPERATION.
- 6. THE CONTRACTOR IS EXPECTED TO PRESERVE THE SYMMETRY OF THE AIRCRAFT SAFETY LINE BASED ON THE DIMENSIONS GIVEN. FOR PAVEMENT MARKINGS NOT GIVEN SPECIFIC DIMENSION, THE CONTRACTOR SHALL MAKE PRELIMINARY MEASUREMENT AND RECORD PRIOR TO REMOVAL OF EXISTING MARKINGS FOR LATER REPLACEMENT.

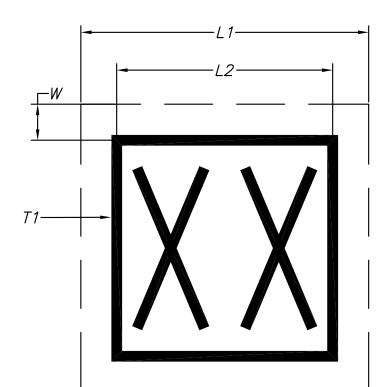

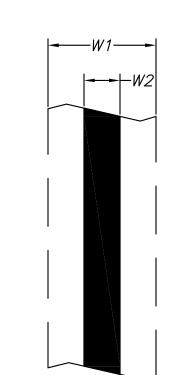

	L1	L2	W	<i>T1</i>	W 1	W2	TEXT
A					18"	6"	
В					24"	16"	
C*	VAR	VAR	6"	6"			12"
D	9'	7'	6"	12"			5'

\*SEE "DETAIL C" FOR PAVEMENT MARKING SPECIFIC CONTENT

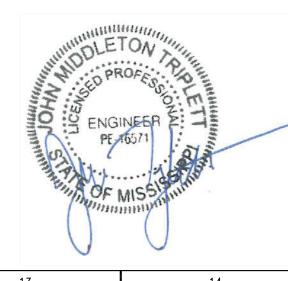



14



Allen & Hoshall, P.L.L.C. Michel Lebel, Architect 1675 Lakeland Drive, Suite 207 Jackson, Mississippi 39216 601 977 8993 fax 601 949 4344

COPYRIGHT
Allen & Hoshall
This document is proprietary to Allen &
Hoshall and shall not be reproduced or used
by others without prior written consent.

JMAA JET BRIDGE 2

JACKSON MUNICIPAL AIRPORT AUTHORITY 100 INTERNATIONAL DRIVE STE 300 JACKSON, MS 39298

JOB NO: 62960
DATE: 8/18/2021
DRAWN: JMT
CHECKED:

CAD FILE:

PM-1